



WILSONVILLE TOD

ADDRESS AT OCCUPANCY:

CONSTRUCTION PHASE DESIGNATION:

LAND USE SUBMISSION 08/18/23

City of Wilsonville

GENERAL NOTES

- APPLICABLE CODES: ALL WORK SHALL BE IN CONFORMANCE WITH ALL FEDERAL, STATE, AND LOCAL CODES. SPECIFICATIONS AND STANDARDS SHALL MEAN, AND ARE INTENDED TO BE, THE LATEST EDITION, AMENDMENT OR REVISION OF SUCH REFERENCE STANDARD(S) IN EFFECT AS OF THE DATE OF THE CONTRACT DOCUMENTS.
- A. WITH REGARD TO ACCESSIBILITY, THE PROJECT SHALL COMPLY WITH THE 1998 FAIR HOUSING ACT DESIGN MANUAL (FHA DM), WITH REFERENCED ANSI A117.1 (2003 VERSION) FOR FHA REQUIREMENTS 1-2 – COMMON/PUBLIC USE AREAS. FHA DM WILL BE THE "SAFE HARBOR". THE PROJECT SHALL ALSO COMPLY WITH THE APPLICABLE ACCESSIBILITY PROVISIONS OF THE 2014 OSSC, AND THE 2010 ADA STANDARDS, APPLICABLE TO THE PUBLIC ACCOMMODATIONS.TOGETHER, THE APPLICABLE PORTIONS OF THESE STANDARDS COMPRISE THE "ACCESSIBILITY REQUIREMENTS"
- THE ARCHITECT IS NOT RESPONSIBLE FOR NON-COMPLIANCE WITH THE ACCESSIBILITY REQUIREMENTS IF THE CONTRACTOR FAILS TO INSTALL A PRODUCT PER THE CONTRACT DOCUMENTS AND/OR IN ACCORDANCE WITH THE MANUFACTURER'S RECOMMENDATIONS OR INSTRUCTIONS.
- GENERAL CONTRACTOR SHALL INDICATE BY WRITTEN DECLARATION (EMAIL TO YBA PROJECT MANAGER IS ACCEPTABLE) PRIOR TO COMMENCEMENT OF WORK THAT THEY HAVE REVIEWED AND ACHIEVED A SATISFACTORY LEVEL OF FAMILIARIZATION WITH THE ANSI/ADA MATERIAL PROVIDED ON SHEETS G-601 - G-606.
- USE DIMENSIONS SHOWN. IN NO CASE SHALL WORKING DIMENSIONS BE SCALED FROM DRAWINGS. IT SHALL BE THE GENERAL CONTRACTOR'S RESPONSIBILITY TO CROSS CHECK DETAILS AND DIMENSIONS SHOWN ON THE ARCHITECTURAL DRAWINGS WITH RELATED REQUIREMENTS ON THE CIVIL, STRUCTURAL, MECHANICAL, ELECTRICAL, PLUMBING AND OTHER DRAWINGS AS APPLICABLE. NOTIFY THE ARCHITECT OF ANY DISCREPANCIES BEFORE
- ALL DIMENSIONS ARE TO FACE OF STUD, CENTER OF CONCRETE WALL, OR STRUCTURAL GRID, UNLESS NOTED OTHERWISE
- CONDITIONS AND DETAILS MARKED "TYPICAL" (TYP.) SHALL APPLY IN ALL CASES UNLESS SPECIFICALLY INDICATED OTHERWISE. TYPICAL DETAILS NOT REFERENCED ON DRAWINGS APPLY UNLESS NOTED OTHERWISE, BY SPECIFIC NOTES AND DETAILS. WHERE NO SPECIFIC DETAIL IS SHOWN, THE CONSTRUCTION SHALL BE IDENTICAL OR SIMILAR TO THAT INDICATED FOR THE TYPICAL CONSTRUCTION ON THE PROJECT.
- WHERE NO SPECIFIC STANDARDS ARE APPLIED TO A MATERIAL OR METHOD OF CONSTRUCTION TO BE USED IN THE MATERIALS, EQUIPMENT, ETC. NOT INDICATED ON DRAWINGS OR SPECIFIED HEREIN, BUT REQUIRED FOR THE SUCCESSFUL AND EFFICIENT COMPLETION OF THE INSTALLATION, SHALL BE HELD TO BE IMPLIED AND SHALL BE
- FURNISHED AND INSTALLED FOR NO ADDITIONAL COST. ERRORS OR OMISSIONS IN ANY SCHEDULE OR DRAWING DO NOT RELIEVE THE GENERAL CONTRACTOR FROM THE WORK INTENDED IN THE CONTRACT DRAWINGS OR DESCRIBED IN THE SPECIFICATIONS, EITHER EXPRESSED OR IMPLIED. A COMPLETE, CURRENT SET OF THE APPROVED CONTRACT DOCUMENTS MUST BE ON THE JOB SITE WHENEVER CONSTRUCTION IS IN PROGRESS. A COMPLETE SET IS DEFINED AS THE ORIGINAL IFC (PERMIT SET W/AHJ COMMENTS
- CONTRACT DOCUMENTS + ASI & RFI'S AND/OR ANY OTHER SUPPLEMENTAL MATERIAL ISSUED BY THE ARCHITECT. THE GENERAL CONTRACTOR SHALL BE RESPONSIBLE FOR PROVIDING ADEQUATE SAFEGUARDS, SAFETY DEVICES, PROTECTIVE EQUIPMENT, FLAGGERS, AND ANY OTHER NEEDED ACTIONS TO PROTECT THE LIFE, HEALTH, AND SAFETY OF THE PUBLIC, AND TO PROTECT PROPERTY IN CONNECTION WITH THE PERFORMANCE OF WORK COVERED BY THE
- DO NOT NOTCH OR DRILL JOISTS, BEAMS, OR LOAD BEARING STUDS WITHOUT THE PRIOR APPROVAL OF THE ARCHITECT AND STRUCTURAL ENGINEER, OR PER MANUFACTURER'S SPECIFICATIONS.
- GENERAL CONTRACTOR TO PROTECT ALL EXTERIOR EXPOSED WORK TO BE INSTALLED IN A WEATHER TIGHT MANNER WIND DAMAGE DURING CONSTRUCTION
- 13. CONSTRUCTION MATERIALS SHALL BE SPREAD OUT IF PLACED ON FRAMED FLOORS OR ROOF. LOAD SHALL NOT EXCEED THE DESIGN LIVE LOAD PER SQUARE FOOT. ALL EXPOSED METAL CONNECTIONS, FASTENERS, COVERS, AND RELATED APPURTENANCES TO BE NON-CORROSIVE
- ALL SEPARATING WALLS AND FLOOR-CEILING ASSEMBLIES, INCLUDING PENETRATIONS OR OPENINGS, SHALL PROVIDE AN AIRBORNE AND IMPACT SOUND INSULATION EQUAL TO SOUND TRANSMISSION CLASS AND IMPACT INSULATION CLASS REQUIRED BY GOVERNING AUTHORITIES; GENERAL CONTRACTOR SHALL PROVIDE CONSTRUCTION METHOD, ACCESSORIES, DEVICES AND APPURTENANCES AS REQUIRED FOR SAME. PROVIDE SEALANT AT ALL OPENINGS MADE IN WALL AND FLOOR SURFACES AND FRAMING FOR SUPPLY AND DRAIN LINES; PROVIDE SEALANT, PUTTY PADS OR OTHER APPROVED MATERIALS TO MAINTAIN ACOUSTICAL REQUIREMENTS AROUND ELECTRICAL OUTLETS AND JUNCTION BOXES. SEE ACOUSTICAL NOTES.
- THE TOP OF SLAB DESIGNATION CORRESPONDS TO THE TOP OF CONCRETE SLAB OR CEMENTITIOUS UNDERLAYMENT AND DOES NOT ACCOUNT FOR THE THICKNESS OF THE FINISHED FLOOR, UNLESS OTHERWISE NOTED. GENERAL CONTRACTOR SHALL PROVIDE ALL WORK IDENTIFIED IN THESE CONSTRUCTION DOCUMENTS IN THE
- CONFIGURATION(S) SHOWN. GENERAL CONTRACTOR SHALL NOT DEVIATE FROM CONFIGURATIONS SHOWN WITHOUT 18. GENERAL CONTRACTOR TO PROTECT PROPERTY AND BUILDING MATERIALS FROM DAMAGE DUE TO CONSTRUCTION.
- INSPECTIONS.
- GENERAL CONTRACTOR TO PROTECT ALL EXISTING FINISHES, CLEAN ALL EXPOSED SURFACES, AND JOB SITE PRIOR TO TURNING SPACES OVER. ANY ELEMENTS OF THE DESIGN THAT ARE DAMAGED, MARRED OR OTHERWISE NOT IN PRISTINE CONDITION, OR OTHERWISE RENDERED OUT OF COMPLIANCE WITH THE DESIGN INTENT DURING AND/OR AS A RESULT OF CONSTRUCTION ACTIVITIES MUST BE REPAIRED OR REPLACED PRIOR TO HAND OVER. THE ARCHITECT RESERVES THE RIGHT TO MAKE ALL DETERMINATIONS OF COMPLIANCE WITH THIS PROVISION. DUST CONTROL MEASURES SHALL BE MAINTAINED THROUGHOUT THE DURATION OF THE PROJECT.
- STABILIZED CONSTRUCTION ENTRANCES SHALL BE INSTALLED AT THE BEGINNING OF CONSTRUCTION AND MAINTAINED FOR THE DURATION OF THE PROJECT. ADDITIONAL MEASURES, SUCH AS CONSTRUCTED WHEEL WASH SYSTEMS OR WASH PADS, MAY BE REQUIRED TO ENSURE THAT ALL PAVED AREAS ARE KEPT CLEAN AND TRACK OUT TO ROAD RIGHT OF WAY DOES NOT OCCUR FOR THE DURATION OF THE PROJECT. PROVIDE FIRE PROTECTION AT PLUMBING CAVITIES OVER 11" IN DEPTH.
- 24. PROVIDE BLOCKING AS REQUIRED TO SUPPORT LIGHTING, FIXTURES, AND/OR ANY FINISH MATERIALS AS REQUIRED. 25. ALL DRIP EDGES ON FLASHING SHALL BE 3/8", UNLESS NOTED OTHERWISE.
- 26. MEP DRAWINGS ARE INDICATIVE IN NATURE AND DO NOT SPECIFICALLY IDENTIFY PRECISE ROUTING OR EQUIPMENT LOCATIONS. IT IS THE RESPONSIBILITY OF THE GC TO COORDINATE WITH THE TRADES TO MAKE THE NECESSARY
- ADJUSTMENTS AS REQUIRED. IF AND WHEN THE DEVIATION BECOMES SO GREAT AS TO ALTER DESIGN INTENT, IT IS INCUMBENT UPON THE GC TO COMMUNICATE THIS TO THE DESIGN TEAM BY RFI WITH ALL HASTE. ENSURE ALL EQUIPMENT, PRODUCTS, APPLIANCES, FIXTURES AND FITTINGS ARE INSTALLED ACCORDING TO THE
- MANUFACTURER'S INSTALLATION INSTRUCTIONS. GENERAL CONTRACTOR TO CAREFULLY REVIEW ANY AND ALL APPLICABLE MANUFACTURER'S INSTALLATION INSTRUCTIONS AND NOTIFY THE DESIGNER OF ANY CONFLICTS WITH THE DESIGN INDICATED IN THE CONTRACT DOCUMENTS PRIOR TO INSTALLATION OR EXECUTION OF THE WORK. GENERAL CONTRACTOR IS RESPONSIBLE TO READ AND FOLLOW ALL REFERENCED STANDARDS FOR PRODUCTS, EQUIPMENT, FIXTURES AND SYSTEMS SPECIFIED FOR THE PROJECT, AND NOTIFY THE ARCHITECT OF ANY CONFLICTS
- WITH THE DESIGN INDICATED IN THE CONTRACT DOCUMENTS PRIOR TO INSTALLATION OR EXECUTION OF THE WORK. THE GENERAL CONTRACTOR UNDERSTANDS THAT PRODUCTS, EQUIPMENT, FIXTURES AND SYSTEMS ARE REPRESENTED IN THE CONTRACT DOCUMENTS INDICATIVELY AND THAT THERE MAY BE SPECIFIC FEATURES, DIMENSIONS OR ELEMENTS THAT ARE NOT EXPLICITLY REPRESENTED IN THE DOCUMENTS AND WHICH MAY REQUIRE COORDINATION IN THE FIELD TO ENSURE INTENDED FUNCTION AND/OR AVOID CONFLICT WITH OTHER ELEMENTS IN THE PROJECT. IT IS THE CONTRACTOR'S RESPONSIBILITY TO CAREFULLY REVIEW AND EVALUATE SUCH ELEMENTS PRIOR TO INSTALLATION AND TO COMMUNICATE TO THE ARCHITECT ANY DEVIATIONS IN THE ACTUAL ELEMENTS FROM WHAT IS REPRESENTED
- THE CONTRACTOR UNDERSTANDS THAT THE AUTHORITY HAVING JURISDICTION (AHJ) HAS DISCRETION TO APPROVE WORK DURING INSPECTIONS AND MAY FAIL WORK THAT IN IT'S VIEW DOES NOT MEET WORKMANSHIP QUALITY AND/OR TOLERANCES DESCRIBED OR IMPLIED IN REFERENCED STANDARDS, PER THE AHJ'S INTERPRETATION OF SUCH STANDARDS. THESE CONTRACT DOCUMENTS ENDEAVOR TO MEET CODE REQUIREMENTS AND TO SPECIFY RELEVANT REFERENCE STANDARDS, BUT DO NOT AND CANNOT PRE-FIGURE THE INTERPRETATIONS OF SUCH STANDARDS BY THE AHJ, WHERE STANDARDS OR CODES DO NOT EXPLICITLY SPECIFY QUANTITATIVE CRITERIA OR CRITERIA THAT CAN BE ABSOLUTELY INTERPRETED. IF AND WHERE AN AHJ INTERPRETS A STANDARD IN A WAY THAT REQUIRES EXPLICIT TOLERANCES OR WORKMANSHIP THAT ARE NOT EXPLICITLY INDICATED IN THE CODE OR REFERENCED STANDARDS OR EXPLICITLY REPRESENTED IN THE CONTRACT DOCUMENTS, IT IS THE RESPONSIBILITY OF THE CONTRACTOR TO MEET THE AHJ'S INTERPRETATION, AND TO ALLOW CONTINGENCY FOR SUCH SITUATIONS AS IT DEEMS NECESSARY.
- FOR ANY ELEMENTS IN THE PROJECT WHERE FINAL COLOR, TEXTURE, FINISH OR OTHER AESTHETIC CHARACTERISTICS ARE NOT EXPLICITLY INDICATED IN THE CONTRACT DOCUMENTS OR WHERE THEY ARE INDICATED AS TO BE DETERMINED BY THE ARCHITECT OR OTHER APPLICABLE DESIGN CONSULTANT, THE RESPONSIBILITY LIES SOLELY WITH THE GENERAL CONTRACTOR TO FORECAST AND DETERMINE A SCHEDULE FOR THE RENDERING OF SUCH DECISIONS BY THE ARCHITECT AND/OR CONSULTANTS DURING CONSTRUCTION, SO AS TO AVOID ANY RISK OF DELAY OR OTHER IMPACT TO THE CRITICAL PATH. THIS SCHEDULE SHALL ASSUME AND PROVIDE FOR A DECISION MAKING PERIOD OF NO LESS THAN 14 CALENDAR DAYS FOR THE ARCHITECT AND/OR CONSULTANTS FROM THE DATE BEYOND WHICH A DELAY IN COMMUNICATING DECISIONS MAY IMPACT THE CONSTRUCTION SCHEDULE. THE GENERAL CONTRACTOR SHALL CLEARLY INTEGRATE THIS SCHEDULE OF DECISIONS AND DECISION MAKING PERIODS INTO THE OVERALL CONSTRUCTION SCHEDULE, REVIEW AND UPDATE IT PERIODICALLY AS REQUIRED AND COMMUNICATE IT IN WRITING
- PROTOCOLS AND RESPONSE PERIODS FOR ALL FORMAL COMMUNICATION DURING THE CONSTRUCTION PHASE ARE INDICATED IN DIVISION 01 OF THE PROJECT MANUAL, AND/OR ARE AS FOLLOWS:
- 35. A. EXCLUDING TIME FOR DELIVERY OF COMMUNICATION TO AND FROM THE CONTRACTOR TO THE ARCHITECT, THE ARCHITECT SHALL RESPOND WITH REASONABLE PROMPTNESS TO ALL REQUESTS FOR INFORMATION, REQUESTS FOR SUBSTITUTION, SUBMITTALS, RE-SUBMITTALS OR OTHER FORMAL COMMUNICATIONS ISSUED BY THE CONTRACTOR WHICH REQUIRE A RESPONSE FROM THE ARCHITECT. THE SAME RESPONSE PERIOD SHALL EXTEND TO ANY OF THE ARCHITECT'S CONSULTANTS.
- 36. B. THE CONTRACTOR SHALL ALLOW SUFFICIENT TIME IN THE PROJECT CONSTRUCTION SCHEDULE FOR ARCHITECT'S AND ARCHITECT'S CONSULTANTS' REVIEW AND RESPONSE PERIODS, INCLUDING TIME FOR RE-REVIEW IF A QUESTION IS POSED IN RESPONSE TO THE CONTRACTOR'S COMMUNICATION THAT REQUIRES A RESPONSE IN TURN BY THE
- CONTRACTOR SHALL COMMUNICATE AND COOPERATE WITH THE AUTHORITY HAVING JURISDICTION (AHJ) TO SCHEDULE ANY PRECONSTRUCTION MEETINGS REQUIRED BY THE AHJ, NOTIFY THE ARCHITECT, OWNER AND ANY OTHER RELEVANT PARTIES OF SUCH MEETINGS, PARTICIPATE IN SUCH MEETINGS AND RECORD AND DISTRIBUTE COPIES OF MINUTES OF SUCH MEETINGS TO THE OWNER AND ARCHITECT WITHIN 2 DAYS.
- 38. CONTRACTOR SHALL COMMUNICATE WITH THE AHJ DURING THE MOBILIZATION PERIOD AND PREPARE ANY SPECIFIC PLANS AND/OR PROTOCOLS REQUIRED BY THE AHJ WITH RESPECT TO MEANS AND METHODS, AND COMPLIANCE WITH THE AHJ'S REGULATIONS PERTAINING TO CONSTRUCTION ACTIVITIES AND CONSTRUCTION SITE FIRE AND LIFE SAFETY. THIS MAY INCLUDE, FOR EXAMPLE, COMPLETION OF A PRE-FIRE PROTECTION PLAN. 'FIRE WATCH' PLAN AND/OR SITE ACCESS AND SECURITY PLAN. 39. IT IS THE RESPONSIBILITY OF THE CONTRACTOR TO CAREFULLY REVIEW AND UNDERSTAND THE DESIGN INTENT
- EXPRESSED IN THE ARCHITECTURAL DOCUMENTS AND PERFORM NECESSARY COORDINATION AMONG IT'S SUBCONTRACTORS AND TRADES TO ENSURE THAT THEIR WORK IS IN ALIGNMENT WITH THE SAME IF THERE APPEARS TO BE DISCREPANCY OR LACK OF INFORMATION BETWEEN THE DESIGN INTENT EXPRESSED IN THE ARCHITECTURAL DOCUMENTS AND OTHER DOCUMENTS. THE CONTRACTOR MUST PREPARE AN RFI IDENTIFYING THE ISSUE(S). 40. WHERE DETAILS ARE PROVIDED THAT APPLY TO MULTIPLE SIMILAR (I.E. "SIM") CONDITIONS, NOT ALL SIMILAR INSTANCES MAY BE TAGGED IN THE DOCUMENTS. IT IS THE CONTRACTOR'S RESPONSIBILITY TO BUILD TO THE SIMILAR CONDITION OR ISSUE A REQUEST FOR INFORMATION IN A TIMELY MANNER TO CONFIRM IF AND WHERE A SIMILAR

DETAIL MAY APPLY TO A CONDITION THAT IS NOT OTHERWISE EXPLICITLY DETAILED AND/OR TAGGED.

WILSONVILLE TOD

CONSTRUCTION PHASE DESIGNATION:

ADDRESS AT OCCUPANCY:

50% CONSTRUCTION DOCUMENTS

- DIMENSIONS SHOWN AS V.I.F. SHALL BE VERIFIED BY THE GENERAL CONTRACTOR IN THE FIELD BY LAYING OUT THE PARTITIONS. CONTRACTOR SHALL NOTIFY DESIGNER OF ANY DISCREPANCY IN DIMENSIONS PRIOR TO PROCEEDING PRIOR TO PURCHASE OR INSTALLATION OF FINISH MATERIALS PER SUBMITTAL LOG, SUBMIT SAMPLES TO DESIGNER
- FOR REVIEW IN CONFORMANCE WITH SPECIFIED PROCEDURES. ALLOW TIME FOR SUBMITTAL REVIEW AND FOR ALL EXPOSED GYPSUM BOARD TO BE LEVEL 4 FINISH UNLESS OTHERWISE SPECIFIED. DIMENSIONS LOCATING DOOR EDGE ARE TO THE INSIDE EDGE OF THE JAMB FRAMING UNLESS OTHERWISE NOTED.
- TRANSITION OF FLOOR MATERIALS TO BE LOCATED AT THE CENTER OF DOOR LEAVES IN CLOSED POSITION UNLESS

GENERAL FINISH NOTES

- ENSURE SURFACES TO RECEIVE FINISHES ARE CLEAN, TRUE, AND FREE OF IRREGULARITIES. DO NOT PROCEED WITH WORK UNTIL UNSATISFACTORY CONDITIONS HAVE BEEN CORRECTED. ALL CODE REQUIRED LABELS SUCH AS 'UL', FACTORY MUTUAL, OR ANY OTHER EQUIPMENT IDENTIFICATION,
- PERFORMANCE RATING, NAME OR NOMENCLATURE PLATES SHALL REMAIN READABLE AND NOT PAINTED. PAINT BACK SIDES OF REMOVABLE ACCESS PANELS AND HINGED COVERS TO MATCH EXPOSED SURFACE. ENSURE ALL EQUIPMENT, PRODUCTS, APPLIANCES, FIXTURES AND FITTINGS ARE INSTALLED ACCORDING TO THE MANUFACTURER'S INSTALLATION INSTRUCTIONS. GENERAL CONTRACTOR TO CAREFULLY REVIEW ANY AND ALL APPLICABLE MANUFACTURER'S INSTALLATION INSTRUCTIONS AND NOTIFY THE DESIGNER OF ANY CONFLICTS WITH
- THE DESIGN INDICATED IN THE CONTRACT DOCUMENTS PRIOR TO INSTALLATION OR EXECUTION OF THE WORK. 10. ALL VISIBLE FACES OF FLASHINGS SHALL BE PAINTED THE SAME FINISH COLOR, INCLUDING THE BACK SIDE OF FLASHINGS OR UNDERSIDE OF FLASHINGS WHERE THOSE FACES ARE VISIBLE. WHERE A FLASHING HAS A FACTORY FINISH AT ONE SIDE, AND THE NON-FACTORY FINISH IS VISIBLE, THE NON-FACTORY FINISH SIDE SHALL BE PAINTED TO MATCH, AT THE DISCRETION OF THE ARCHITECT AND AT NO ADDITIONAL COST.
- ALL SPRINKLER HEADS AND ACCORDING ESCUTCHEON PLATES WHERE VISIBLE AT EXTERIOR LOCATIONS SHALL BE BLACK, UNLESS OTHERWISE NOTED; FIRE SUPPRESSION SYSTEM SUBMITTALS SHALL CLEARLY INDICATE THE COLOR OF HEADS AND ESCUTCHEONS WHERE THEY ARE VISIBLE. ALL VISIBLE SPRINKLER PIPES SHALL BE PAINTED AT THE DISCRETION OF THE ARCHITECT AND AT NO ADDITIONAL COST.

GENERAL BUILDING CODE NOTES

- THE MEANS OF EGRESS, INCLUDING THE EXIT DISCHARGE, SHALL BE ILLUMINATED AT ALL TIMES THE BUILDING IS OCCUPIED. EGRESS LIGHTING WILL BE PROVIDED SO THAT IT ILLUMINATES THE EGRESS PATH TO 1 FT CANDLE MEASURED AT THE FLOOR. THE POWER SUPPLY FOR THE EGRESS LIGHTING SHALL BE PROVIDED BY THE PREMISES ELECTRICAL SUPPLY. EMERGENCY POWER SUPPLY PROVIDED TO MEET OR EXCEED 90 MINUTES IN OPERATIONAL
- EXITS AND EXIT ACCESS SHALL BE MARKED WITH APPROVED EXIT SIGNS THAT ARE READILY VISIBLE FROM ANY DIRECTION OF TRAVEL. IN INSTANCES WHERE THE EXIT OR THE EXIT PATH ISN'T IMMEDIATELY VISIBLE, ADDITIONAL
- EXIT SIGNS SHALL BE ADDED. THE FLOORS OF TOILET AND SHOWER ROOMS SHALL HAVE A SMOOTH, HARD, NON-ABSORBENT SURFACE. THE INTERSECTION OF SUCH FLOORS WITH WALLS SHALL HAVE A SMOOTH, HARD, NON-ABSORBENT VERTICAL BASE THAT EXTENDS UPWARDS AT LEAST 4". WALLS AND PARTITIONS WITHIN 2 FEET OF SERVICE SINKS, URINALS, AND WATER CLOSETS SHALL HAVE A SMOOTH , HARD, NON-ABSORBENT SURFACE TO A HEIGHT OF 4 FEET ABOVE THE
- ELEVATORS WILL MAINTAIN A MINIMUM 10 FOOT CANDLES AT FLOOR LEVEL IN FRONT OF THE ELEVATOR DOOR AT EACH FLOOR LEVEL LANDING AND MINIMUM 18 FOOT CANDLES AT ELEVATOR CONTROL PANEL(S) AND SHALL COMPLY WITH ALL CURRENTLY APPLICABLE CODES.
- FIRE BLOCKING SHALL BE INSTALLED IN ACCORDANCE WITH THE REQUIREMENTS PRESCRIBED IN THE OSSC. SPECIAL ATTENTION SHALL BE PAID TO CONCEALED WALL SPACES (DOUBLE WALLS, FURRED WALLS, STAGGERED STUDS ETC;) THAT EXCEED 10' IN EITHER HORIZONTAL OR VERTICAL DIMENSIONS. IT IS INCUMBENT UPON THE GC TO VERIFY CODE COMPLIANT BLOCKING HAS BEEN INSTALLED THAT "BREAKS" THE CONCEALED SPACES INTO AREAS NO GREATER THAN 10'X10'.
- DRYWALL AT ALL RESTROOMS, ROOMS CONTAINING HOT WATER HEATERS AND MOP SINKS SHALL BE MOISTURE RESISTANT, UNLESS SPECIFIED OTHERWISE.
- AT ALL RESIDENTIAL UNITS, BLOCKING FOR GRAB BARS SHALL BE PROVIDED FOR BOTH 'ANSI TYPE A' AND 'ANSI TYPE B' UNITS REGARDLESS OF WHETHER GRAB BARS ARE ACTUALLY TO BE INSTALLED.

GENERAL FIRE SAFETY NOTES

- SEPARATE PERMITS SHALL BE OBTAINED FROM THE CITY OF GRESHAM'S PERMIT CENTER FOR ALTERATIONS TO THE FIRE ALARM AND FIRE SPRINKLER SYSTEM.
- A MINIMUM ONE 2A10BC RATED PORTABLE FIRE EXTINGUISHERS SHALL BE INSTALLED PER THE REQUIREMENTS OF THE FIRE MARSHALL AND THE OREGON FIRE CODE (OFC).
- EVERY ROOM OR SPACE THAT IS AN ASSEMBLY OCCUPANCY SHALL HAVE THE OCCUPANT LOAD OF THE ROOM OR SPACE POSTED IN A CONSPICUOUS PLACE.
- FIRE BLOCKING SHALL BE PROVIDED IN ACCORDANCE WITH THE REQUIREMENTS OF THE 2014 OREGON STRUCTURAL SPECIALTY CODE (OSSC) AND THE OREGON FIRE CODE (OFC). ALL PERMITS ARE TO BE OBTAINED FROM THE GRESHAM PERMIT CENTER, NOT THE FIRE MARSHAL'S OFFICE
- INFORMATION, PROCEDURES, MATERIALS, & TECHNIQUES FOR COMPLIANT FIRE SAFING & CAULKING FOR PENETRATIONS OF FIRE RATED ASSEMBLIES IS ENUMERATED IN THE PROJECT MANUAL SECTION 07 84 13-3.
- TEMPORARY ADDRESSES OF 6" SHALL BE PROVIDED AT EACH CONSTRUCTION ENTRANCE PRIOR TO ANY CONSTRUCTION MATERIALS OR WORKERS ONSITE. OFC 505 & 3301 THE BUILDING ADDRESSING SHALL MEET THE GRESHAM FIRE ADDRESSING POLICY. OFC 505.1
- FIRE HYDRANT LOCATIONS SHALL BE IDENTIFIED BY THE INSTALLATION OF BLUE REFLECTIVE MARKERS, LOCATED ADJACENT AND TO THE SIDE OF THE CENTERLINE OF THE ACCESS ROAD WAY THAT THE FIRE HYDRANT IS LOCATED ON . IN THE CASE THAT THERE IS NO CENTER LINE, THEN ASSUME A CENTERLINE AND PLACE THE MARKER ACCORDINGLY. OFC 508.5.4
- "NO PARKING FIRE LANE" SIGNAGE OR CURB MARKING IS REQUIRED PER OFC D 103.6 11. ALL FIRE DEPARTMENT ACCESS ROADS SHALL BE CONSTRUCTED AND MAINTAINED PRIOR TO AND DURING CONSTRUCTION. OFC 1410
- ACCESS ROADS SHALL NOT EXCEED 10% GRADE. OFC 503.2.7
- CONTRACTOR WILL SUPPLY A HAZARDOUS MATERIAL INVENTORY STATEMENT (HMIS) SHOWING TYPES AND QUANTITIES OF ALL HAZARDOUS MATERIAL. OFC 407.5/5001.5.2
- 14. FIRE APPARATUS ACCESS SHALL COMPLY WITH THE REQUIREMENTS OF OFC 503 AND SHALL EXTEND TO WITHIN 50 FEET OF ALL PORTIONS OF THE FACILITY AND ALL PORTIONS OF THE EXTERIOR WALLS OF THE FIRST STORY O THE BUILDING AS MEASURED BY AN APPROVED ROUTE AROUND THE EXTERIOR OF THE BUILDING. OFC 503.1.1

GENERAL FIRE SUPPRESSION SYSTEM NOTES

- NFPA 13 SPRINKLER & STANDPIPE INSTALLATION AND DESIGN UNLESS EXPLICITLY INDICATED IN THE DOCUMENTS, ALL SPRINKLER PIPING SHALL BE DESIGNED TO BE CONCEALED. IF AND WHERE ANY PROPOSED PIPING CANNOT BE CONCEALED, THE CONTRACTOR MUST PROMPTLY NOTIFY THE ARCHITECT BY RFI OR OTHERWISE ENDEAVOR TO MODIFY THE FIRE SUPPRESSION DESIGN TO AVOID EXPOSED PIPING. THE ARCHITECT HAS THE RIGHT TO REQUIRE THE PROPOSED FIRE SUPPRESSION SYSTEM DESIGN BE REVISED TO AVOID EXPOSED PIPING. THIS RIGHT IS PRESERVED REGARDLESS OF SHOP DRAWING AND/OR SUBMITTAL REVIEW AND MAY BE EXERCISED UPON OBSERVATION OF AN EXPOSED CONDITION IN THE FIELD AFTER PIPING HAS BEEN INSTALLED. THE
- SUBCONTRACTOR. SPRINKLER SHOP DRAWINGS AND MATERIAL SUBMITTALS SHALL BE SUBMITTED TO THE ARCHITECT & ENGINEER FOR REVIEW. REVIEW OF SUCH SUBMITTALS IS NOT FOR THE PURPOSE OF DETERMINING THE ACCURACY AND COMPLETENESS OF OTHER INFORMATION SUCH AS DIMENSIONS, QUANTITIES, AND INSTALLATION OR PERFORMANCE OF EQUIPMENT OR SYSTEMS, WHICH ARE THE CONTRACTOR'S RESPONSIBILITY. THE ARCHITECT'S REVIEW OF FIRE SUPPRESSION SUBMITTALS IN NO WAY RELIEVES THE CONTRACTOR FROM THE OTHER REQUIREMENTS IN THIS SECTION AND DOES NOT IMPLY THAT SUCH REQUIREMENTS HAVE BEEN MET. THE GC SHALL BE RESPONSIBLE FOR COORDINATING THE COMPLETE FIRE SUPPRESSION SUBMISSION AND ITS COMMUNICATION TO THE AHJ. THE SUBMISSION SHALL BE APPROVED BY THE AHJ PRIOR TO ANY INSTALLATION.

CONTRACTOR MUST ALLOW FOR ADEQUATE DESIGN AND COORDINATION SCOPE WITH ITS FIRE SUPPRESSION

- 4. IT IS THE RESPONSIBILITY OF THE GC TO COORDINATION WITH OTHER TRADES TO AVOID IN FIELD CLASHES. FAILURE TO SATISFACTORILY DEMONSTRATE PRIOR COORDINATION SHALL NEGATE THE RIGHT TO ANY CLAIMS FOR ADDITIONAL
- 5. IT IS THE RESPONSIBILITY OF THE GC & FIRE SUPPRESSION SYSTEM DESIGNER TO BE FAMILIAR WITH THE OTHER TRADES DESIGN AND REQUIREMENTS. IT IS THE RESPONSIBILITY OF THE GC TO PROVIDE THE FIRE SUPPRESSION DESIGNER WITH THE MEP CONTRACT DOCUMENTS AND SUBMITTALS FOR COORDINATION WITH SPECIFIC EQUIPMENT AND LAYOUTS. THE GC WILL ALSO PROVIDE THE FIRE SUPPRESSION DESIGNER WITH THE ARCHITECTURAL AND STRUCTURAL ENGINEERING DRAWINGS WITH THE EXPECTATION THAT THE DESIGNER AND GC HAVE REVIEWED AND ARE FAMILIAR
- PIPING IN AREAS WITH EXPOSED STRUCTURE SHALL BE INSTALLED AS HIGH AS POSSIBLE TO ALLOW THE OWNER MAXIMUM USE OF THE SPACE.
- REFER TO ARCHITECTURAL REFLECTED CEILING PLANS FOR CEILING DESCRIPTIONS AND HEIGHTS. SLEEVE AND/OR FIRESTOP ALL PENETRATIONS THROUGH RATED WALLS, CEILINGS, AND FLOORS WITH U/L LISTED ASSEMBLIES. FIRESTOP ASSEMBLIES SHALL BE EQUAL OR EXCEED THE RATING OF THE WALL, CEILING OR FLOOR. SEE ARCHITECTURAL DRAWINGS FOR FINAL FINISHES.
- PROVIDE ACCESS PANELS TO ALL VALVES ABOVE NON-ACCESSIBLE CEILINGS AND CHASES, AND WHEREVER OTHERWISE
- 10. COORDINATE PIPING WITH ALL ELECTRICAL EQUIPMENT (PANELS, TRANSFORMERS, ETC.) PRIOR TO ANY INSTALLATION. DO NOT ROUTE ANY PIPING OVER ANY ELECTRICAL PANELS UNDER ANY CIRCUMSTANCES. ANY PIPING RUN OVER ELECTRICAL SHALL BE REROUTED AT NO ADDITIONAL COST.
- PIPES, VALVES AND OTHER FIRE SUPPRESSION EQUIPMENT SHALL BE KEPT CLEAR OF THE LIMIT OF PROTRUDING OBJECTS AS SET OUT IN 2009 ANSI 117.1. IF AND WHERE SUCH OBJECTS INFRINGE UPON THIS ZONE, THEY SHALL BE REROUTED OR OTHERWISE PROTECTED TO BE COMPLIANT AT NO ADDITIONAL COST.

GENERAL ACOUSTICAL NOTES

- ALL OUTLETS AND OTHER PENETRATIONS (MUDRINGS, ETC.) HAVE A HILTI CP 617 PUTTY PAD COVERING THE ENTIRE
- ALL LAYERS OF GYPSUM BOARD IN THE DEMISING WALLS AND CORRIDOR WALLS NEED TO BE SEALED WITH RESILIENT CAULK AT THE CEILING, FLOOR, AND VERTICAL JUNCTIONS. INCLUDING THE JUNCTION WITH THE CORRIDOR AND
- ALL PENETRATIONS THROUGH DEMISING WALLS AND UNIT CORRIDOR WALLS NEED TO BE SEALED WITH RESILIENT
- WHEN POSSIBLE, BACK TO BACK OUTLETS (ELECTRICAL, LOW VOLTAGE, WATER VALVE BOXES, ETC) SHOULD BE SPACED 24 INCHES APART IN UNIT DEMISING WALLS AND UNIT CORRIDOR WALLS. FILL ALL PENETRATED AREAS OF THE FLOOR ASSEMBLY. SEAL WITH FIRE STOP STUFFED INTO THE GAPS AND NON-
- HARDENING CAULK COVERING THE SURFACES. RECESSED CEILING MOUNTED JUNCTION BOXES SHOULD BE COMPLETELY COVERED IN PUTTY PADS OR BOXED WITH 2
- LAYERS OF 5/8" GYPSUM BOARD AND SEALED (AIRTIGHT) WITH ACOUSTICAL CAULK. RECESSED CAN LIGHTS SHOULD BE BOXED IN WITH 2 LAYERS OF 5/8" GYPSUM BOARD AND SEALED (AIRTIGHT) WITH

GENERAL SUBMITTAL NOTES

- ARCHITECTS REVIEW IS FOR GENERAL CONFORMANCE WITH THE DESIGN CONCEPT OF THE PROJECT AND THE INFORMATION GIVEN IN THE CONTRACT DOCUMENTS. THE CONTRACTOR IS SOLELY RESPONSIBLE FOR, AND THIS REVIEW DOES NOT INCLUDE: CONFIRMING AND CORRELATING ALL QUANTITIES AND DIMENSIONS; COORDINATING THE WORK WITHOUT OF THE OTHER TRADES AND PERFORMING ALL WORK IN A SAFE AND SATISFACTORY MANNER. CORRECTIONS OR COMMENTS MADE DURING THE SUBMITTAL REVIEW DO NOT RELIEVE THE CONTRACTOR FROM COMPLIANCE WITH THE REQUIREMENTS OF THE CONTRACT DOCUMENTS OR WITH HIS RESPONSIBILITIES LISTED
- ABOVE AND ON NOTATIONS PROVIDED ON THIS SHEET. THE CONTRACTOR IS EXPECTED TO HAVE ADEQUATELY MADE TIME & EFFORT TO COMPETENTLY REVIEW ALL MATERIALS, MEANS AND METHODS WHEN REVIEWING SUBMITTALS/SHOP DRAWINGS. THIS INCLUDES BUT IS NOT LIMITED TO FIELD VERIFICATION OF ALL DIMENSIONS PRIOR TO BOTH ISSUANCE OF THE SUBMITTAL FOR REVIEW AS WELL AS A FINAL VERIFICATION PRIOR TO COMMENCEMENT OF WORK. THE ACT OF TRANSMITTING THESE DOCUMENTS FOR ARCHITECTS REVIEW, CERTIFY THIS EFFORT HAS BEEN UNDERTAKEN WITH DUE CONSIDERATION OF THE COMMENTS PROVIDED IN THIS NOTE, SHEET AND SPECIFICATIONS. SUBMITTALS THAT DO NOT DEMONSTRATE PRIOR SATISFACTORY REVIEW WILL BE SUMMARILY RETURNED AS REJECTED. WHEN THE ARCHITECT REJECTS A SUBMITTAL BECAUSE IT HAS NOT BEEN ADEQUATELY REVIEWED BY THE CONTRACTOR, ANY DELAY OR ADDITIONAL COST INCURRED AS A RESULT IS SOLELY THE RESPONSIBILITY OF THE CONTRACTOR.

PROJECT TEAM

Palindrome Communities 412 NW 5th Ave, Suite 200, Portland, OR 97209 CONTACT: Robert Gibson 503-288-6210 Ext. 325

rgibson@pacificap.com

CONTRACTOR Pacificap Construction 615 S Farmer Ave, Suite 1003, Tempe, AZ 85281

503-288-6210 jellis@pacificap.com ARCHITECT

CONTACT: Jason Ellis

CIVIL

503-747-9638

YBA Architects 3514 N Vancouver Ave, Ste. 310, Portland, OR 97227 **CONTACT: Tim Schneider** 701.400.0017 tim@yb-a.com

Emerio Design 6445 SW Fallbrook Pl Suite 100, Beaverton, OR, 97008 CONTACT: Steve Hansen

steveh@emeriodesign.com

LANDSCAPE Shapiro Didway 1204 SE Water Ave, Suite 21, Portland, OR 97214 CONTACT: Brenda Fairbanks

503.232.0520 brenda@shapirodidway.com

STRUCTURAL Valar Consulting Engineering 12042 SE Sunnyside Rd, Suite 357, Clackamas, OR 97015

CONTACT: Bassam Bazzi 503-250-4581 bassam.bazzi@valarengineering.com

MECHANICAL Ocean Park Mechanical 7235 SW Bonita Rd, Tigard, OR 97224 CONTACT: Andrew Pavao 510-850-6548

ELECTRICAL Mill Plain Electric 6000 NE 88th St, Vancouver, WA 98665 **CONTACT: Mark Divine** 360-953-3660 markd@mp-electric.com

PLUMBING Tapani Plumbing 2103 SE 12th Ave, Battle Ground, WA 98604 CONTACT: Dean Lee 360-953-9869 deanl@tapaniplumbing.com

FIRE SUPPRESSION

glinnell@coscofire.com

andrew@oceanpm.com

Cosco Fire 2501 SE Columbia Way, Suite 100, Vancouver, WA 98661 CONTACT: Gerry Linnell 360-816-8408

AREA MAP



DRAWING LIST

FLOOR PLAN - LEVEL 2 (LU)

FLOOR PLAN - LEVEL 3 (LU)

FLOOR PLAN - LEVEL 4 (LU)

FLOOR PLAN - LEVEL 5 (LU)

EXTERIOR ELEVATIONS (LU)

EXTERIOR ELEVATIONS (LU)

EXTERIOR ELEVATIONS (LU)

BUILDING SECTIONS (LU)

BUILDING SECTIONS (LU)

RENDERINGS & EXTERIOR MATERIALS

ROOF PLAN (LU)

ET#	SHEET TITLE	SHEET#	SHEET TITLE
-			
	COVER SHEET		
	PROJECT INDEX - LAND USE		
	EXISTING CONDITIONS / SURVEY		
	TENTATIVE PARTITION PLAT		W large March Hamp God
			A lad had had f
	EXISTING CONDITIONS AND DEMOLITION PLAN		
	SITE GRADING PLAN		PLANNING
	SITE GRADING PLAN AT EXISTING TREES		I LANGUING I
	UTILITY PLAN		
	ROW STORMWATER PLANTERS		4/1 2 . 1
			NV 1 10 801 17
NPE .			WINTY-AA
	EXISTING TREE INVENTORY PLAN		CITY DE AUI C
	LEVEL 1 MATERIALS PLAN	L	CITY COVILS
	LEVEL 2 LANDSCAPE PLANS		
	LEVEL 1 PLANTING PLAN		
	MITIGATION PLAN		
CTURAL			
	LAND USE SITE PLAN		
	EXTERIOR SIGNAGE PLAN		
	EXTERIOR LIGHTING PLAN		
	FLOOR PLAN - LEVEL 1 (LU)		
	EL 0.00 DI ANI LEVEL 2 (111)		



T: 971.888.5107 - E-MAIL: INFO@YB-A.COM

REFERENCE

REVISION NO. EVENT

WILSONVILLE TOD

PALINDROME COMMUNITII

LAND USE REVIEW

PROJECT NUMBER

220120 08/18/23


FULL SHEET SIZE

30 X 42 DRAWING TITLE

PROJECT INDEX - LAND USE

SHEET NUMBER



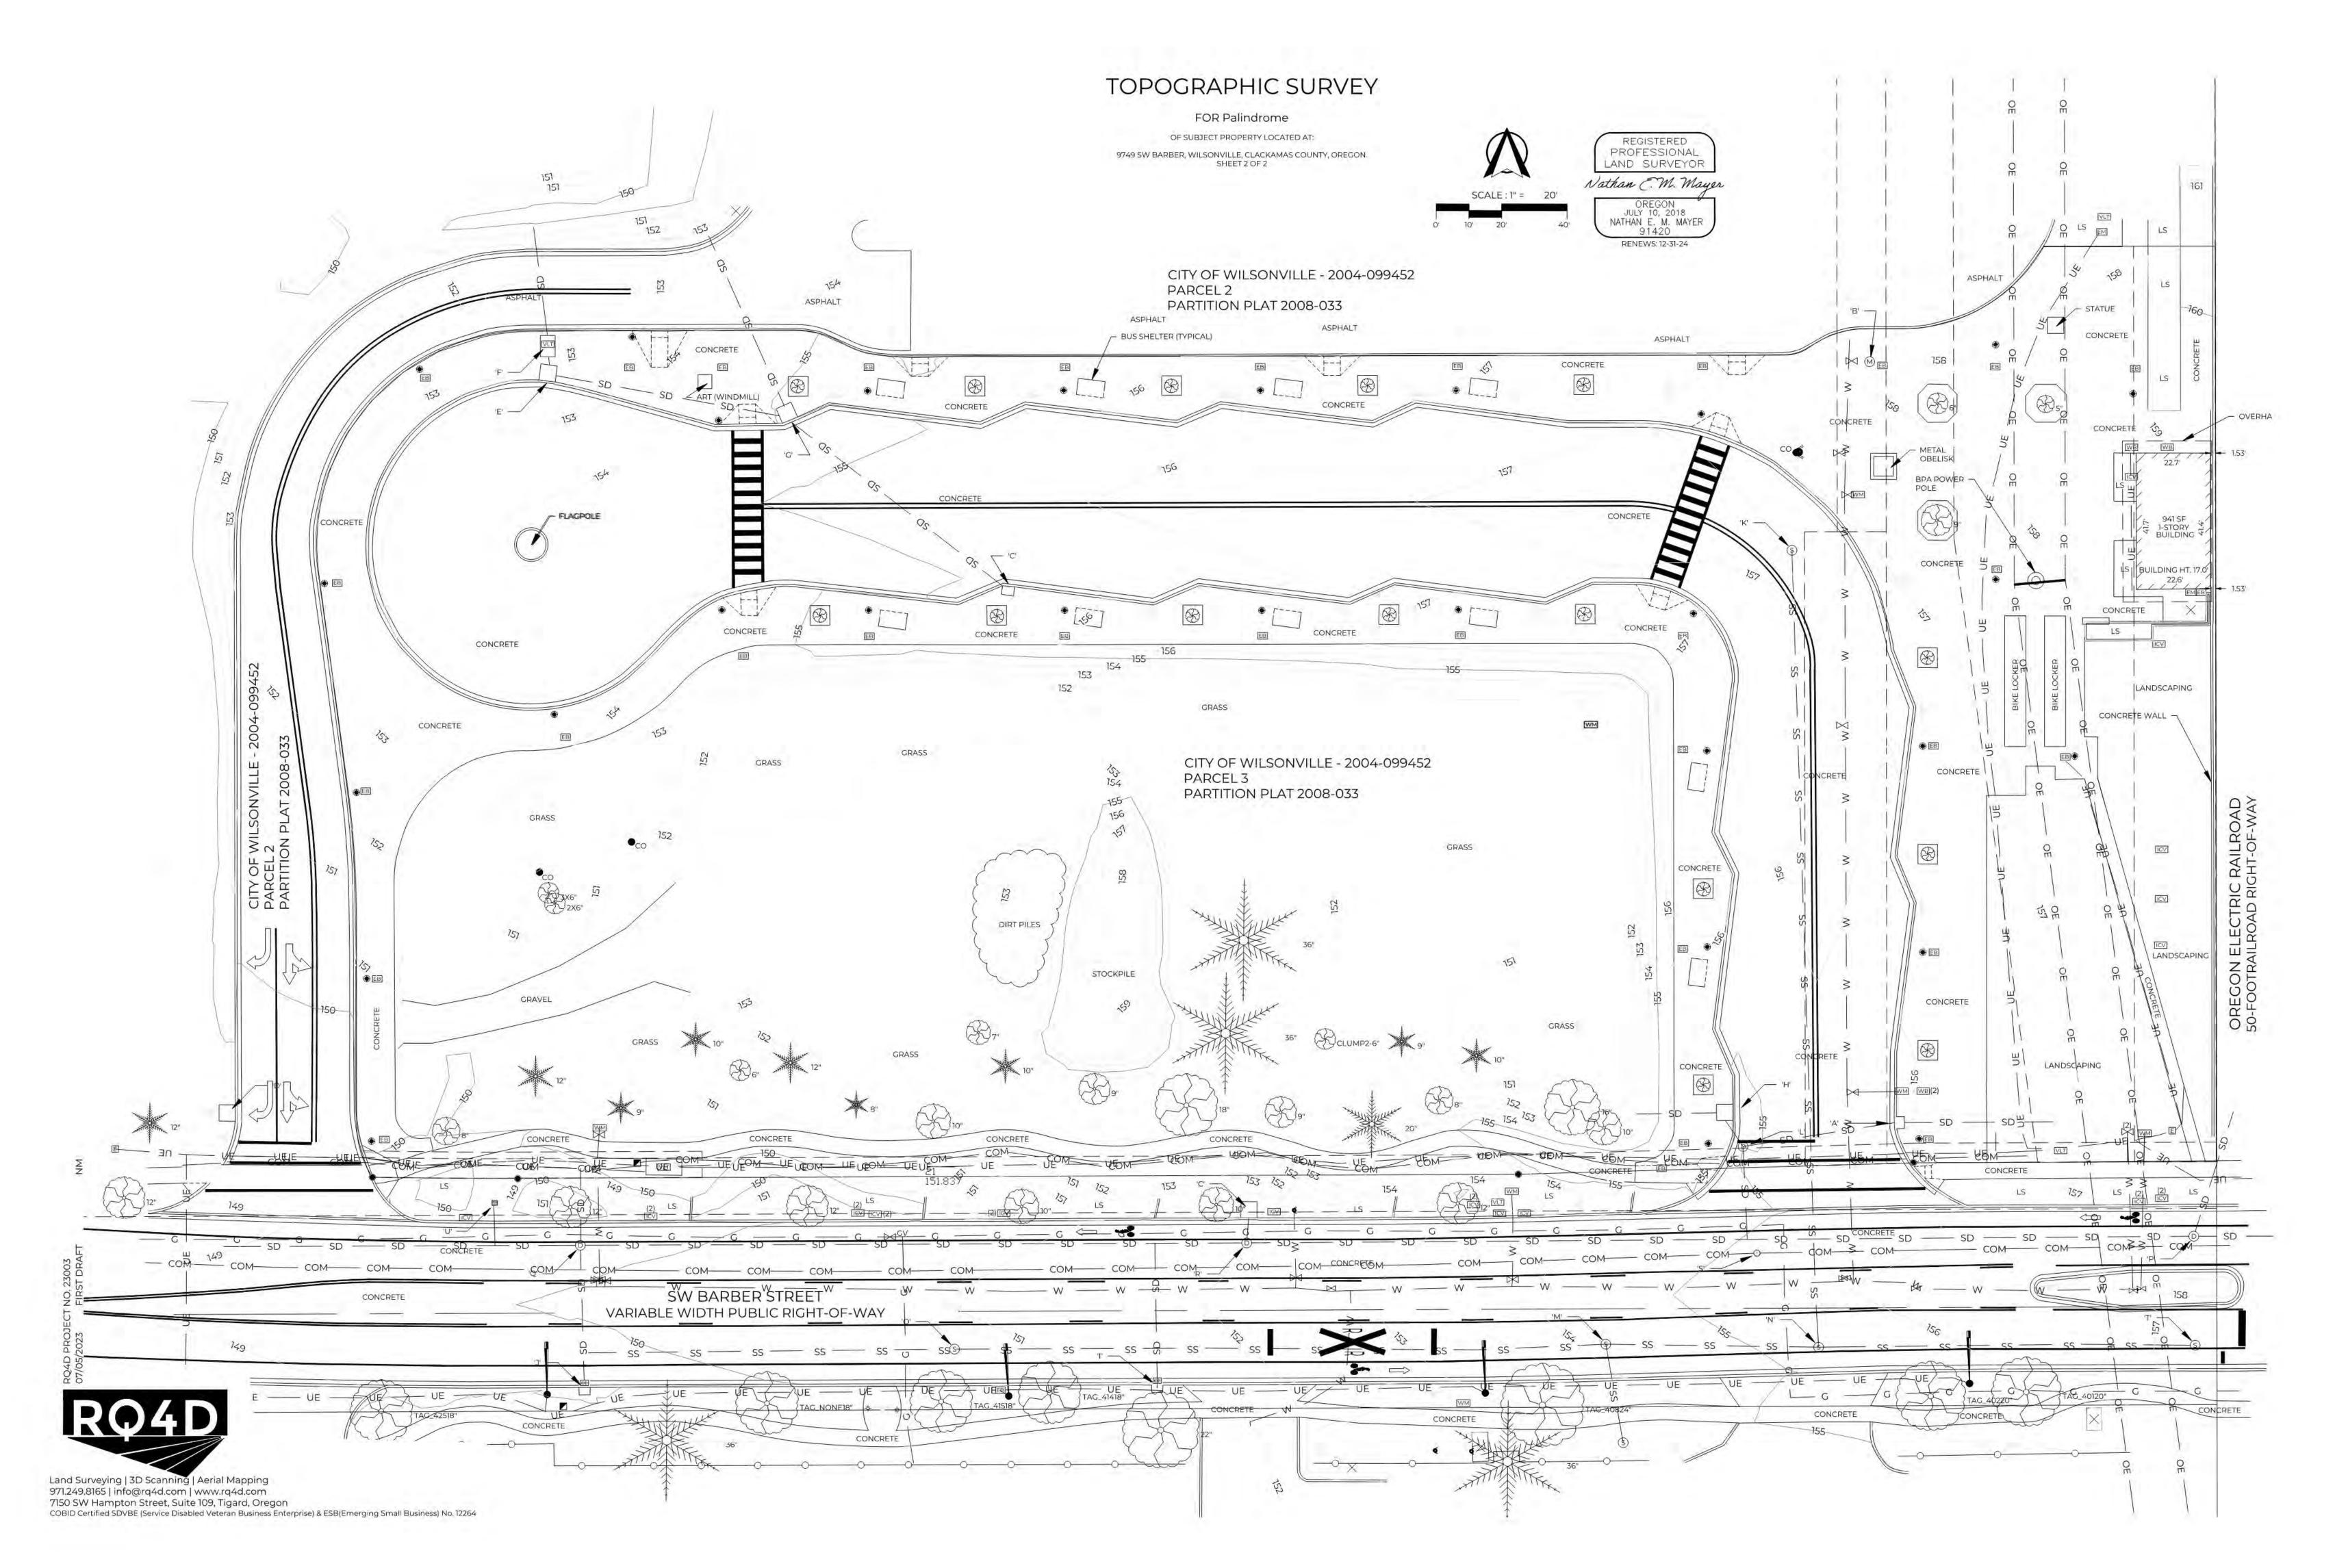

FOR REFERENCE ONLY

SHEET REVISION REVISION REVISION NO. EVENT DATE

TRUE NORTH

WILSONVILLE TOD

PALINDROME COMMUNITIES

ISSUANCE

LAND USE REVIEW

PROJECT NUMBER

220120 DATE 08/18/23

08/18/23 FULL SHEET SIZE 30 X 42

EXISTING CONDITIONS / SURVEY

SHEET NUMBER

G3

SURVEYOR'S NARRATIVE

THE PURPOSE OF THIS SURVEY:
TO PARTITION PARCEL 3, PARTITION PLAT 2008-033, CLACKAMAS COUNTY PLAT RECORDS, INTO TWO

BASIS OF BEARINGS:

THE BASIS OF BEARINGS.

THE BASIS OF BEARINGS IS THE RECORD RELATIONSHIP BETWEEN FOUND MONUMENTS (503) AND (504), REFERENCE DOCUMENT [1], WHERE THE BEARING IS HELD TO BE S 89°46'47" W.

BOUNDARY PROCEDURE:

THE SURVEY OF SAID PARCEL 3 WAS RETRACED. ALL MONUMENTS WERE FOUND ALONG THE SOUTHERLY LINES, SOUTHERLY CURVE AND THE EASTERLY LINE. THE WESTERLY AND NORTHERLY LINES AND CURVES MONUMENTS WERE FOUND TO BE OBLITERATED BY CONSTRUCTION; HOWEVER, SAID LINES AND CURVES GENERALLY COINCIDE WITH EXISTING CONCRETE CURB. SAID FOUND MONUMENTS WERE FOUND TO BE IN HARMONY WITH THE RECORD GEOMETRY OF REFERENCE DOCUMENT [1]. THE

BOUNDARY IS RESOLVED HOLDING SAID FOUND MONUMENTS AND RECORD GEOMETRY.

CURVE TABLE								
CURVE	DELTA	RADIUS	LENGTH	CHORD	CHORD BRG			
C1	89°57'53"	12.00	18.84	16.97	N45°06'49"W			
C2	46°36'04"	39.00	31.72	30.85	S66°36'13"W			
С3	47°05'58"	64.00	52.61	51.14	S66°51'09"W			
C4	90°43'34"	40.00	63.34	56.93	S45°02'21"W			
C5	0°54'41"	1961.50	31.20	31.20	S89°46'16"E			
C10 [1]	60°30'00"	49.50	52.27	49.87	S59°41'11"W			
C11 [1]	35°57'02"	29.50	18.51	18.21	S71°57'39"W			
C12 [1]	35°57'02"	12.50	7.84	7.72	S71°57'39"W			
C13 [1]	29°55'35"	30.50	15.93	15.75	N75°06'02"W			
C14 [1]	29°55'35"	29.50	15.41	15.23	N75°06'02"W			
C15 [1]	97°38'07"	65.50	111.62	98.59	S41°07'07"W			
C16 [1]	7°38'07"	300.50	40.04	40.02	S3°52'53"E			
C17 [1]	33°08'48"	29.50	17.07	16.83	S16°38'14"E			
C18	0°23'24"	1961.50	13.35	13.35	S89°07'14"E			

C19 0°54'41" 1961.50 31.20 31.20 S89°46'16"E

PARTITION PLAT NO. _____

BEING A PORTION OF THE NW 1/4 OF SECTION 14, TOWNSHIP 3 SOUTH, RANGE 1 WEST OF THE WILLAMETTE MERIDIAN, CITY OF WILSONVILLE, CLACKAMAS COUNTY, OREGON

CITY OF WILSONVILLE PLANNING FILE NO. XXXXXXX DECEMBER 11, 2023 SHEET 1 OF 2

	FOUND MONUMENTS
#	DESCRIPTION
00	1-1/16-INCH BRASS DISC STAMPED "53760", FLUSH, GOOD CONDITION
501	5/8-INCH IR W/YPC, UP 0.4', CAP SPLIT
02	5/8-INCH IR W/YPC STAMPED "PLS53760", FLUSH, GOOD CONDITION
603	1-1/16-INCH BRASS DISC STAMPED "53760", FLUSH, GOOD CONDITION
504	1-1/16-INCH BRASS DISC STAMPED "53760", FLUSH, GOOD CONDITION
99	5/8-INCH IR W/YPC STAMPED "DEHASS & ASSOC. INC", UP 0.3', GOOD CONDITION

LEGEND:

- O FOUND MONUMENT AS NOTED
- SET 5/8-INCH IR 30-INCH LONG WITH AN ORANGE PLASTIC CAP STAMPED "RQ4D 91420" UNLESS OTHERWISE NOTED ON XX XXXXX XX
- [#] DOCUMENT REFERENCE NUMBER
- ### MONUMENT REFERENCE NUMBER

(#) MONUMENT REFERENCE NUMBER


(M)MEASURED


IR IRON ROD

W/YPC WITH YELLOW PLASTIC CAP

REFERENCE DOCUMENTS:

[1]PARTITION PLAT, PP2008-033, CLACKAMAS COUNTY, OREGON

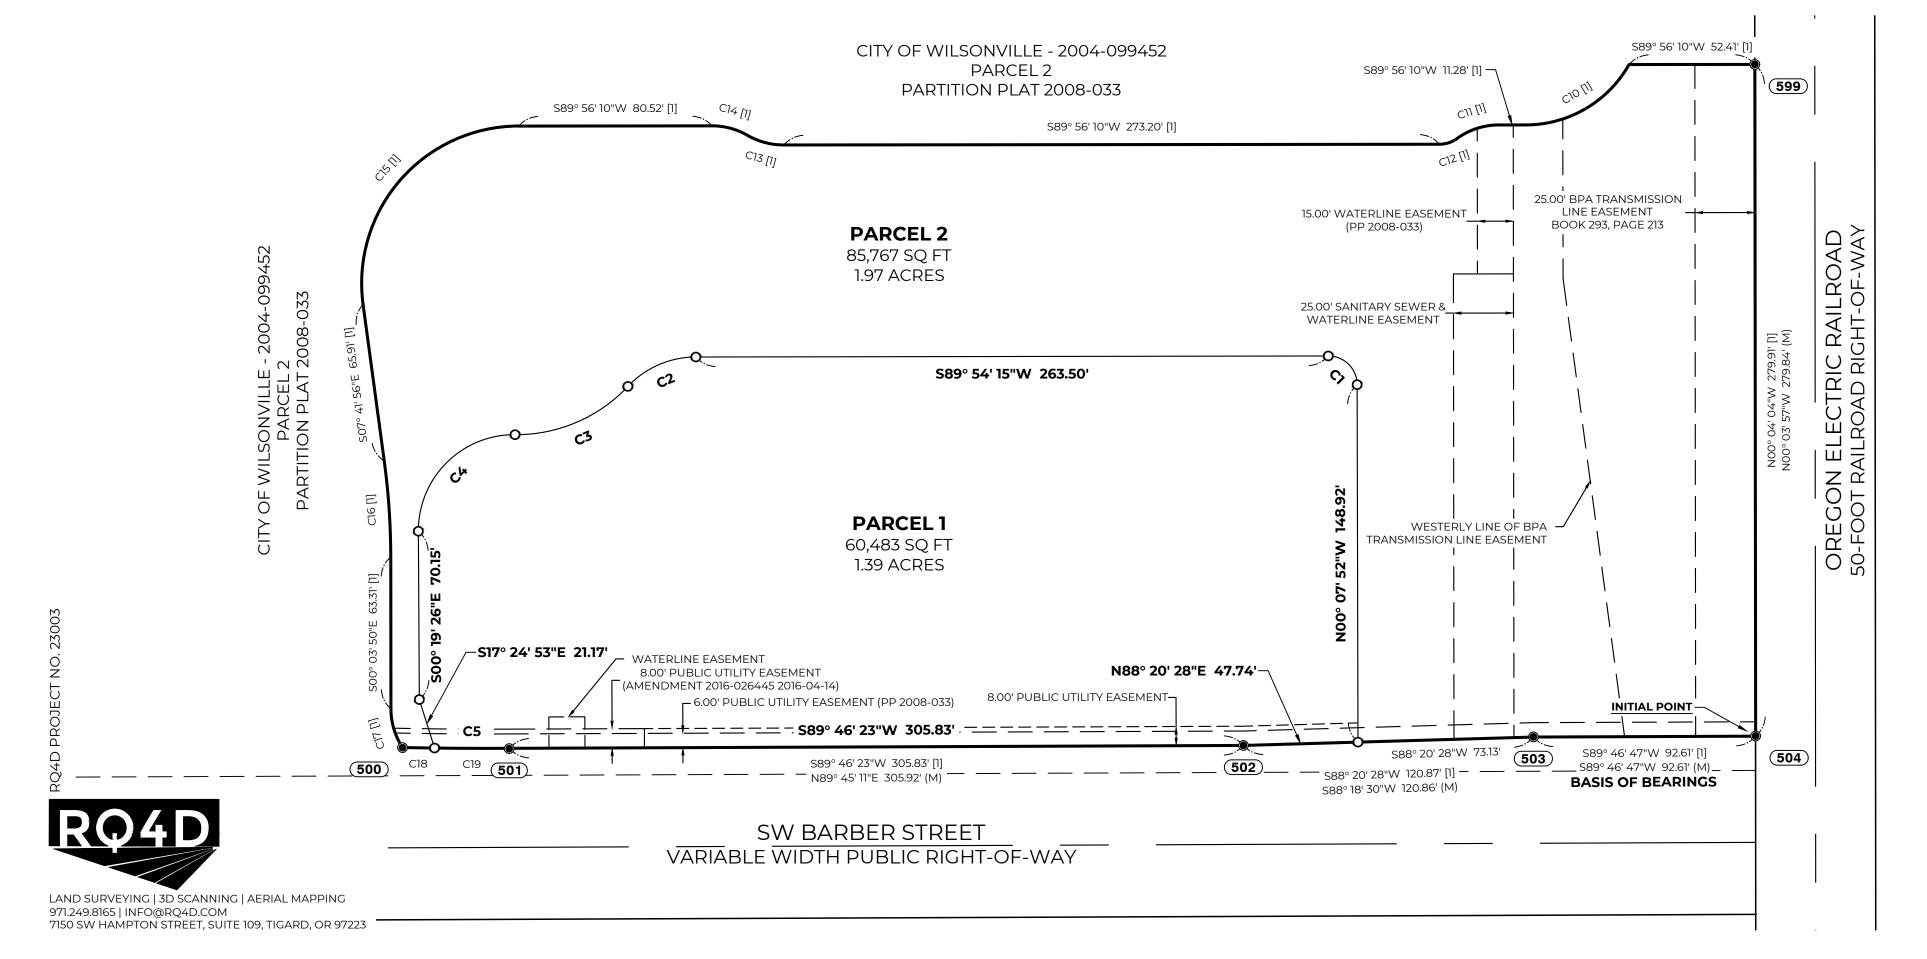

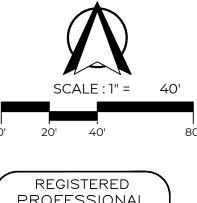

REGISTERED
PROFESSIONAL
LAND SURVEYOR

PRELIMINARY

OREGON
JULY 10, 2018
NATHAN E. M. MAYER
91420

RENEWS: 12-31-24

30 X 42


DRAWING TITLE


TENTATIVE PARTITION PLAT

SHEET NUMBER

G4



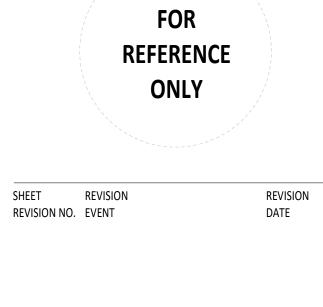

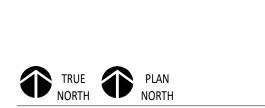

WILSONVILLE TOD

PALINDROME COMMUNITIES


LAND USE REVIEW

PROJECT NUMBER

220120

DATE **08/18/23**

FULL SHEET SIZE

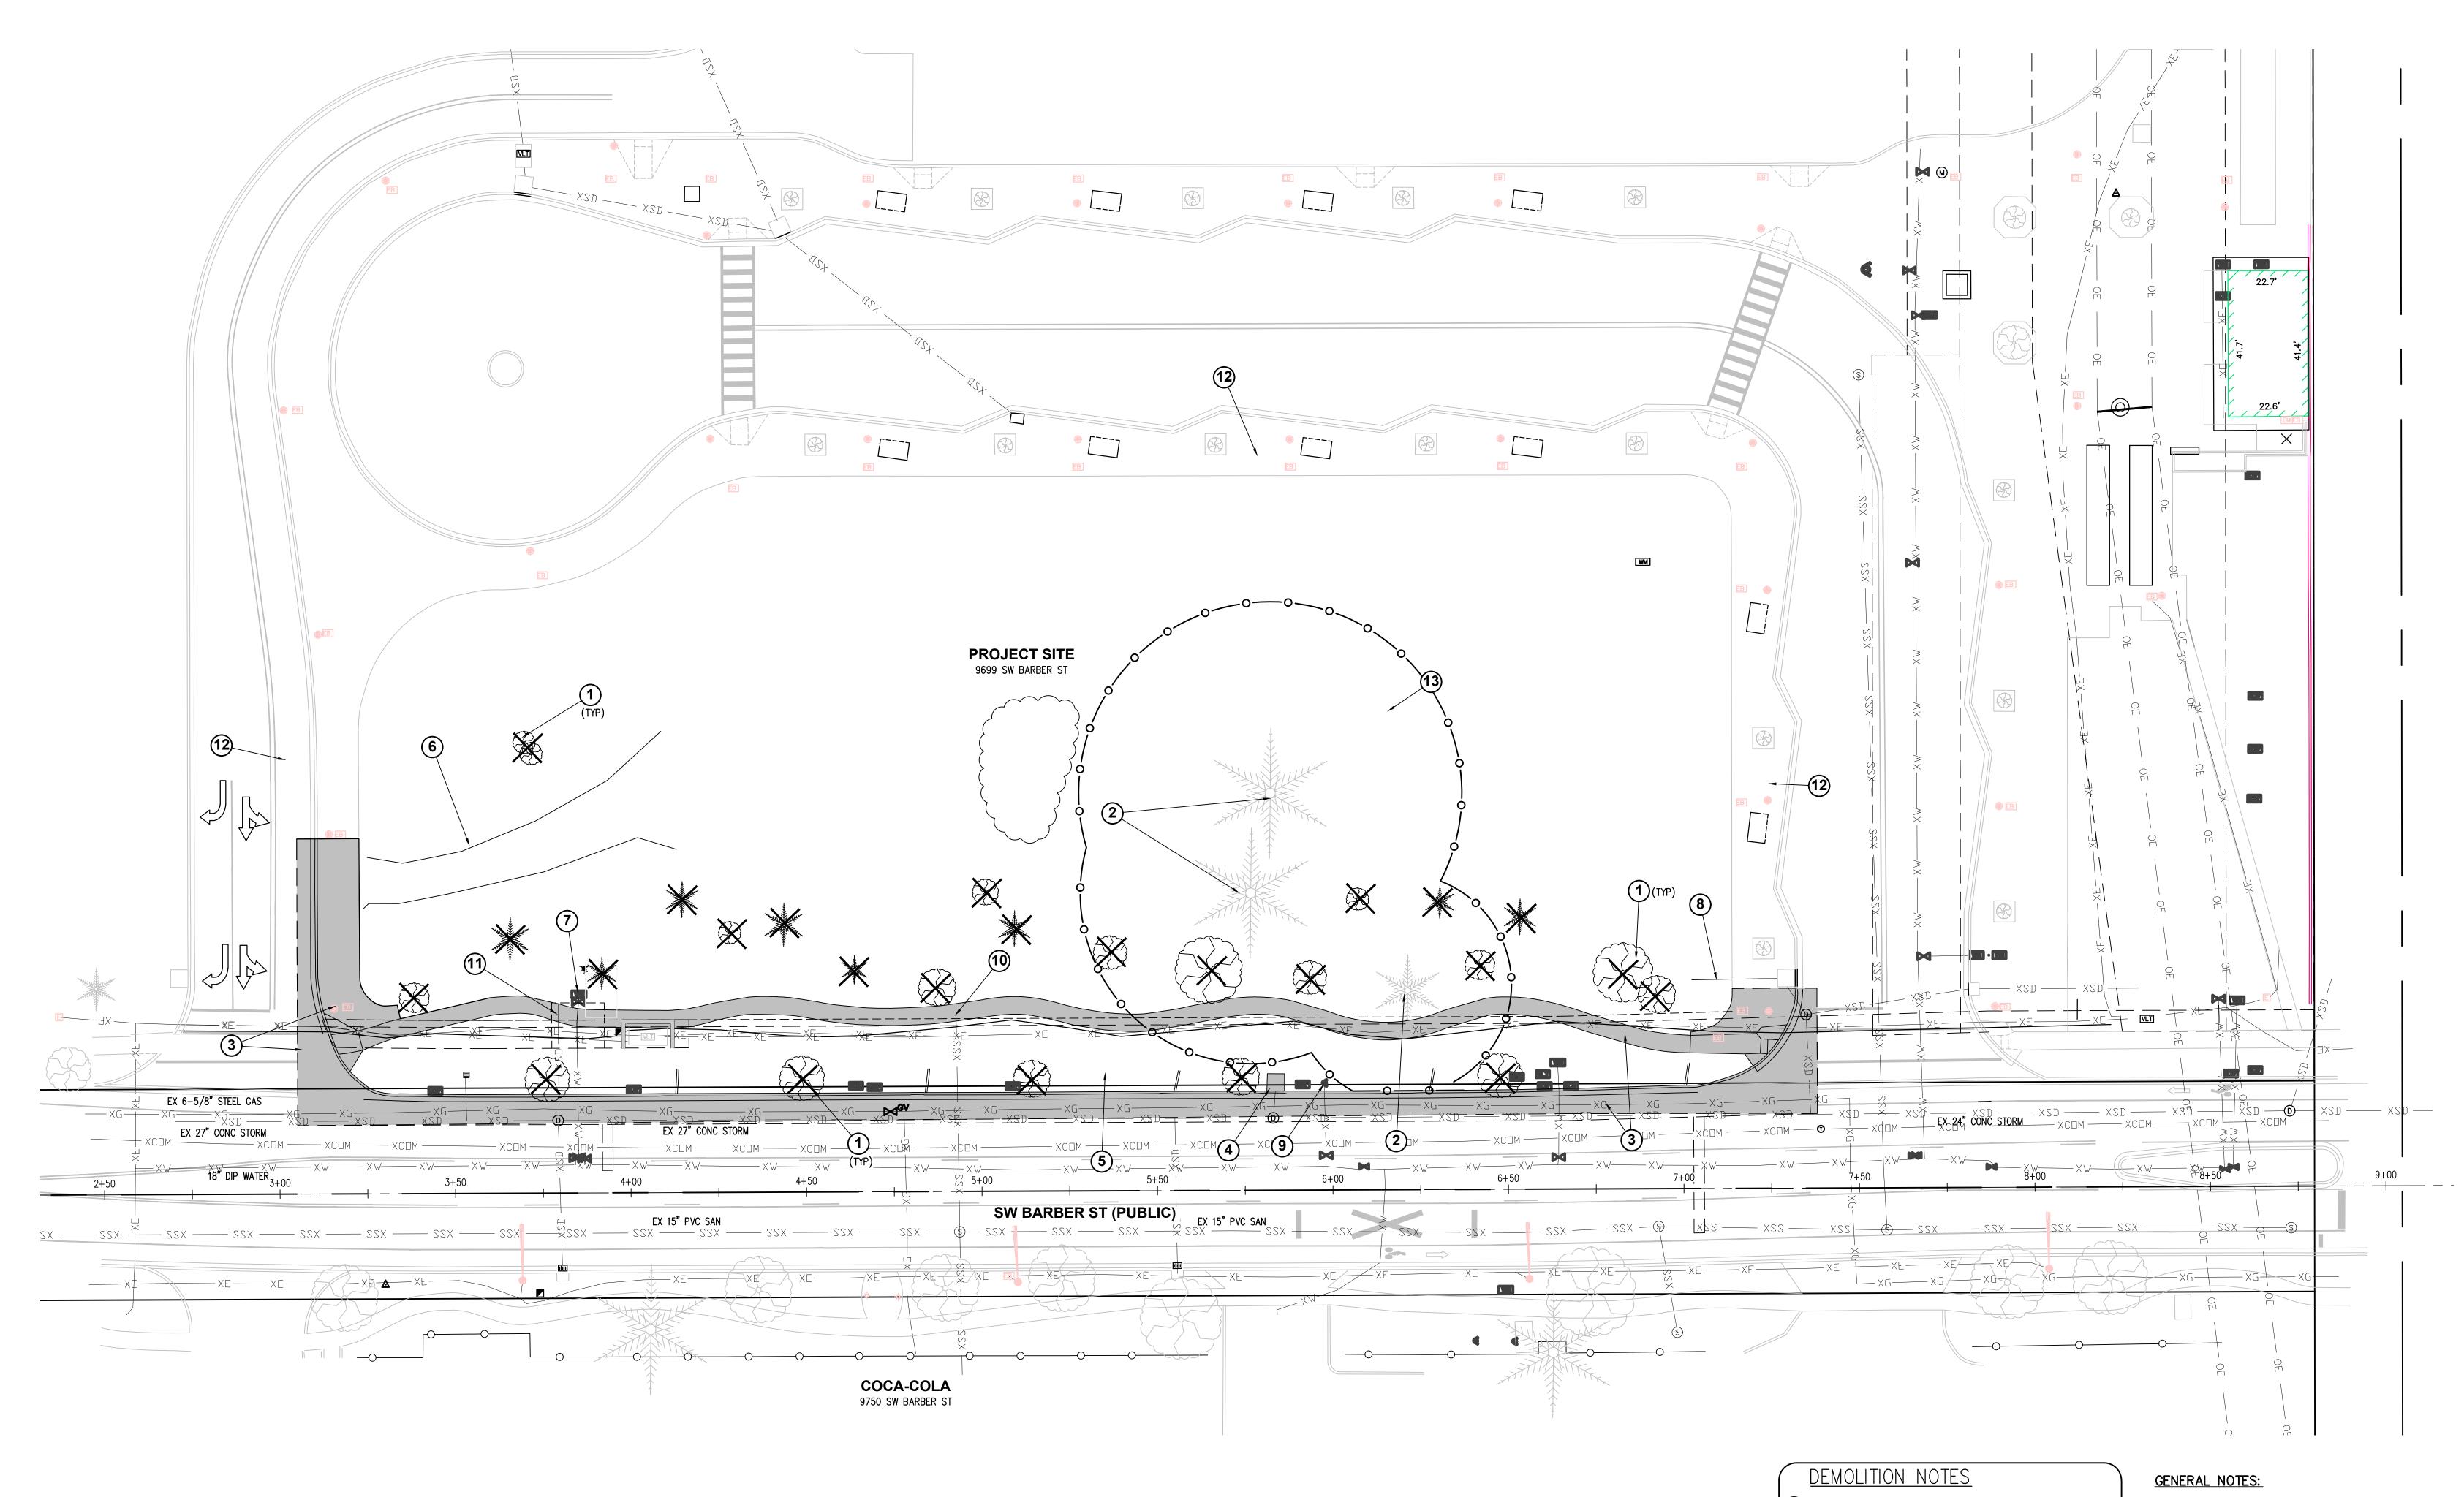

1 EXISTING TREE TO BE REMOVED AND DISPOSED OF OFF SITE. 1. SEE ARBORIST REPORT & TREE PROTECTION PLAN BY PETER VAN OSS OF TERAGAN & ASSOCIATES, INC, "WILSONVILLE TOD PROJECT" DATED JULY 25, 2023, FOR MORE INFORMATION ON TREE PROTECTION

SCALE: 1" = 20'

(2) existing tree to remain and be protected.

6 EXISTING GRAVEL DRIVEWAY TO BE REMOVED

(3) SAWCUT AND REMOVE EXISTING SIDEWALK, CURB AND GUTTER

EXISTING INLET TO BE REMOVED. EXISTING INLET LEAD TO BE CAPPED AND ABANDONED

EXISTING STORMWATER PLANTER SYSTEM TO BE DEMOLISED, INCLUDING CURB INLETS, IRRIGATION SYSTEM, AND IRRIGATION CONTROL VALVES

7 EXISTING WATERLINE AND STRUCTURES TO BE DEMOLISHED AND CAPPED AT PROPERTY LINE

(10) EXISTING SANITARY SEWER LATERAL TO REMAIN AND BE PROTECTED

(11) EXISTING STORM DRAIN LATERAL TO REMAIN AND BE PROTECTED/

13) INSTALL TREE PROTECTIVE FENCING. ROOT PROTECTION ZONE FENCING CONSISTING OF SIX-FOOT METAL CHAIN-LINK FENCE

PLACED ALONG THE EDGE OF THE ROOT PROTECTION ZONE.

SECURED WITH 8-FOOT METAL POSTS IN THE GROUND MUST BE

8 EXISTING STORM LINE TO BE CAPPED AND ABANDONED

9 EXISTING HYDRANT TO REMAIN AND BE PROTECTED

(12) EXISTING SIDEWALK TO REMAIN AND BE PROTECTED

PALINDROME COMMUNITIES

TRUE PLAN NORTH

WILSONVILLE TOD

REVISION NO. EVENT

DATE

architects

3514 N VANCOUVER AVE SUITE 310 - PORTLAND, OR 97227 T: 971.888.5107 - E-MAIL: INFO@YB-A.COM

BHAVEHNEND/REPECOND/RIP/2008

TEL: (503) 746-8812

FAX: (503) 639-9592

www.emeriodesign.com

LAND USE REVIEW

PROJECT NUMBER


220120 08/18/23


FULL SHEET SIZE 30 X 42 DRAWING TITLE


EXISTING CONDITIONS AND **DEMOLITION PLAN**

SHEET NUMBER

C1.00

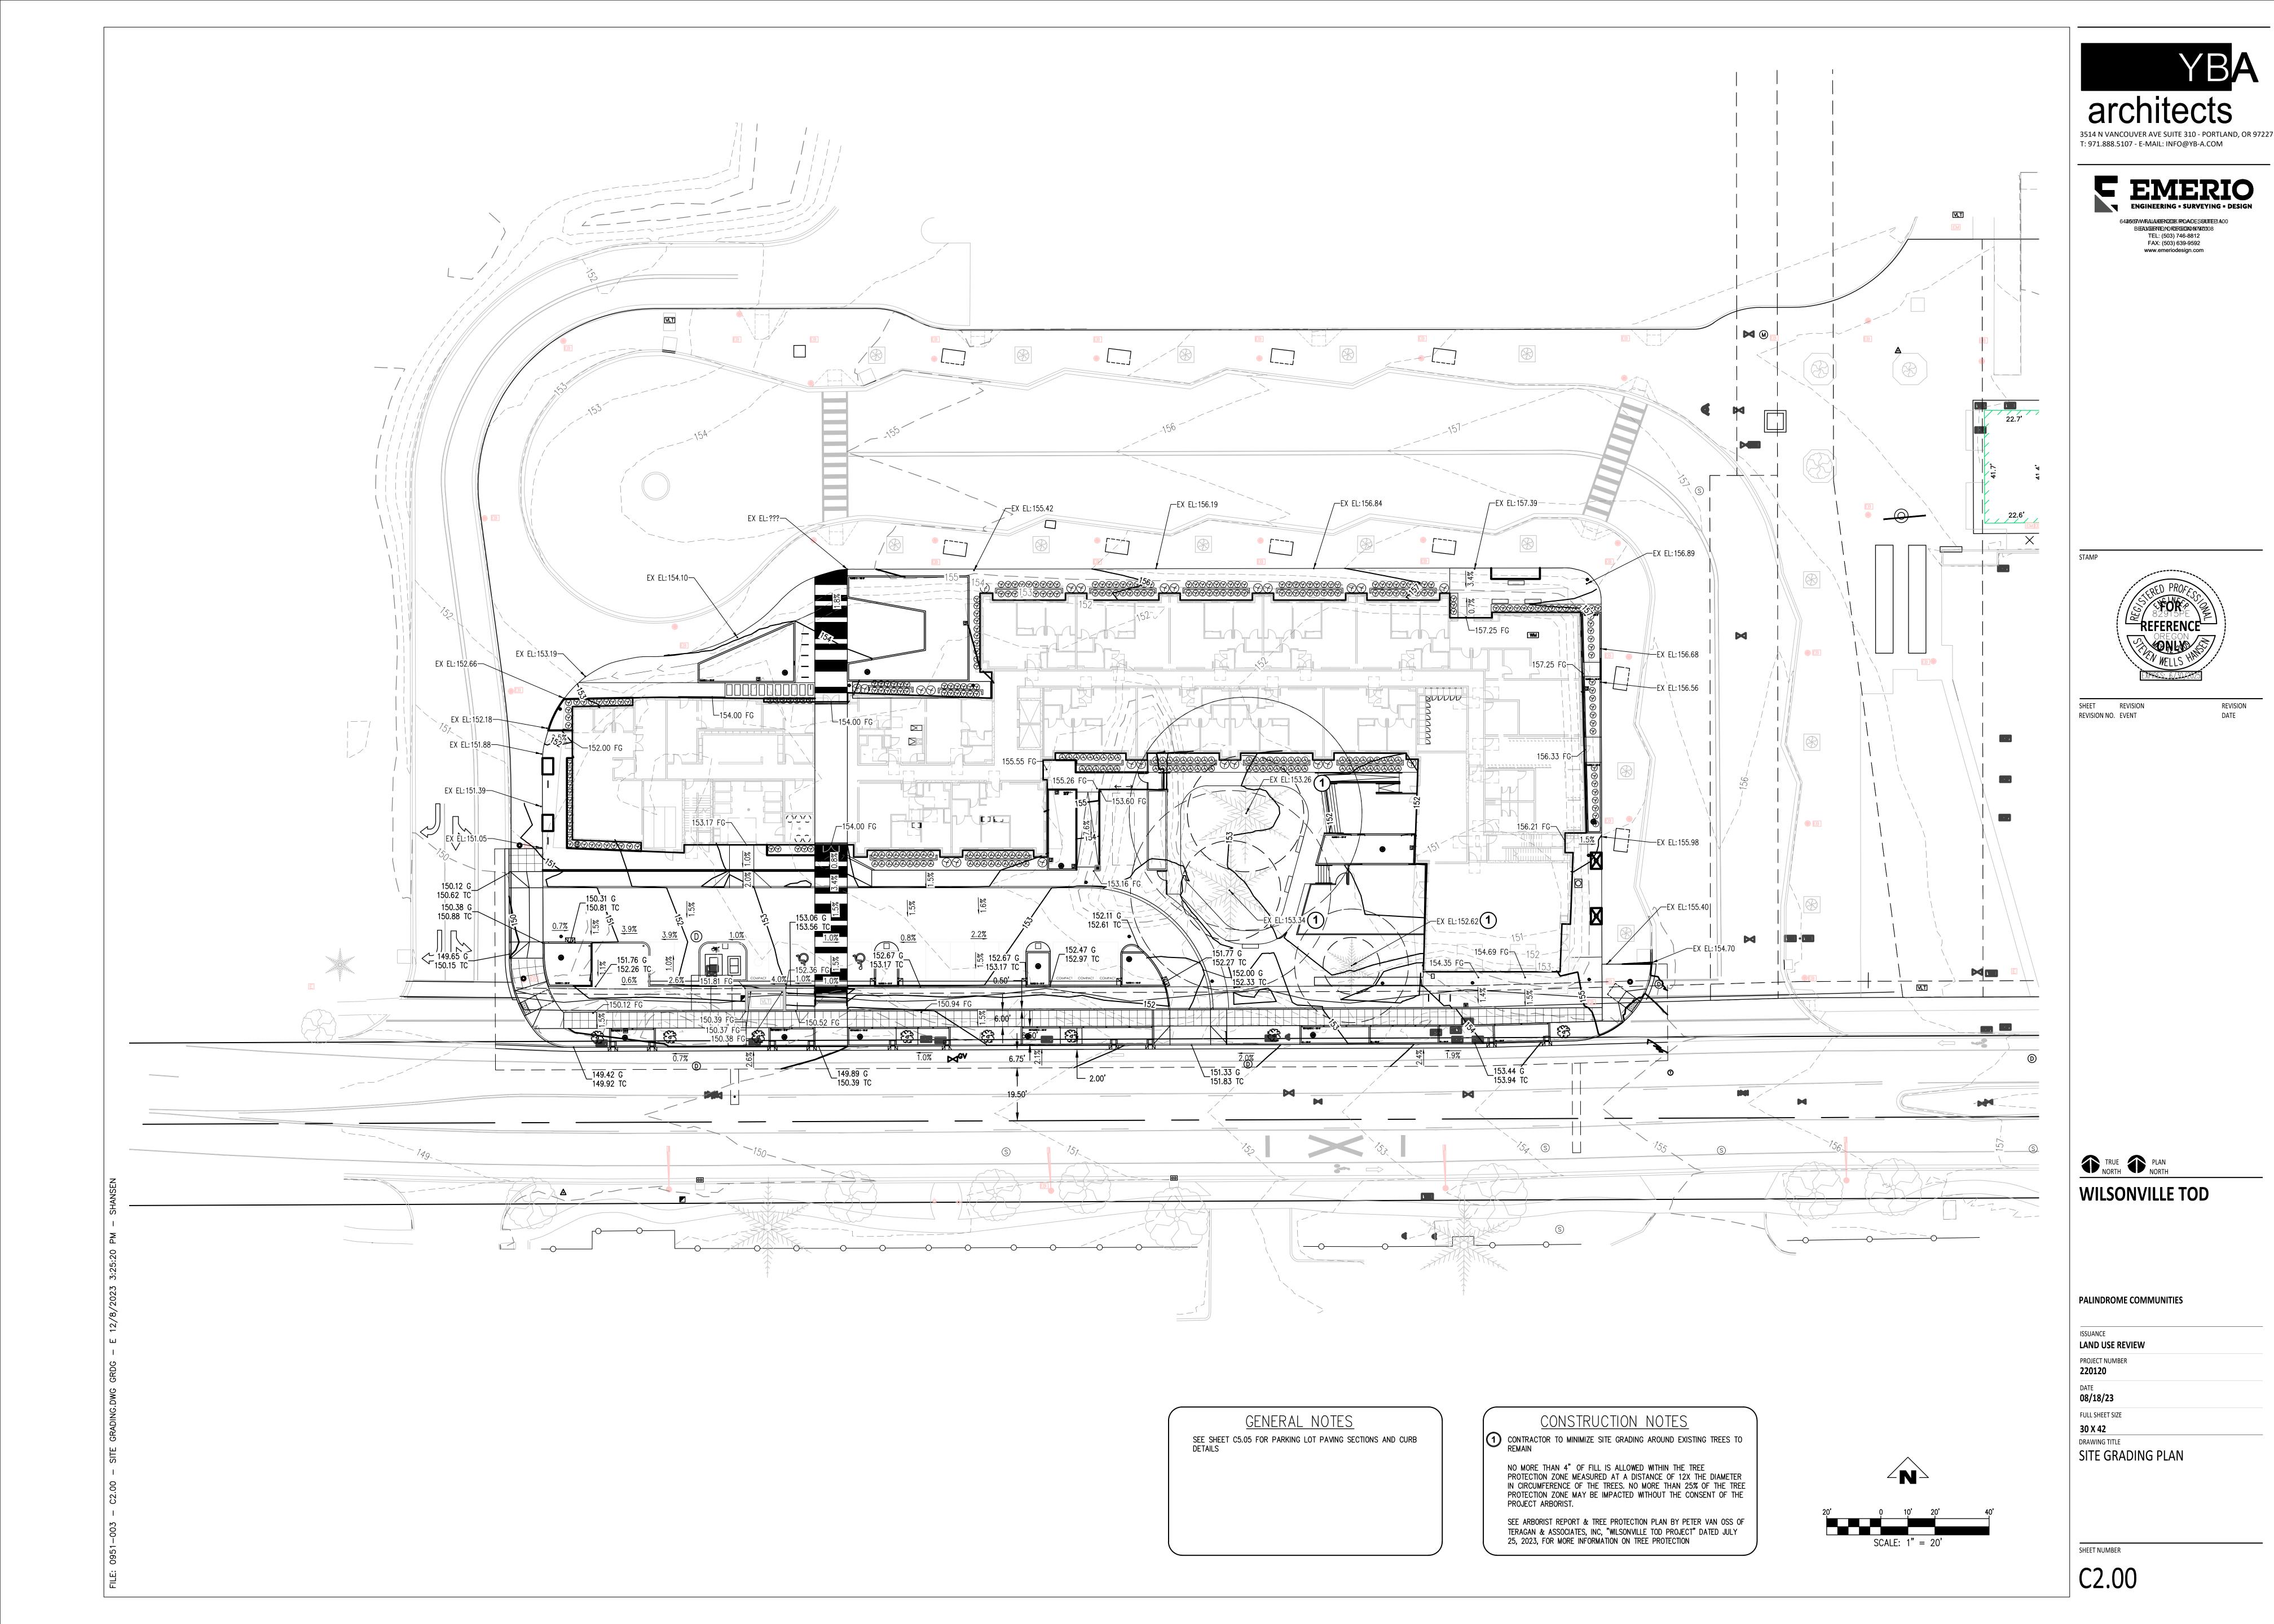

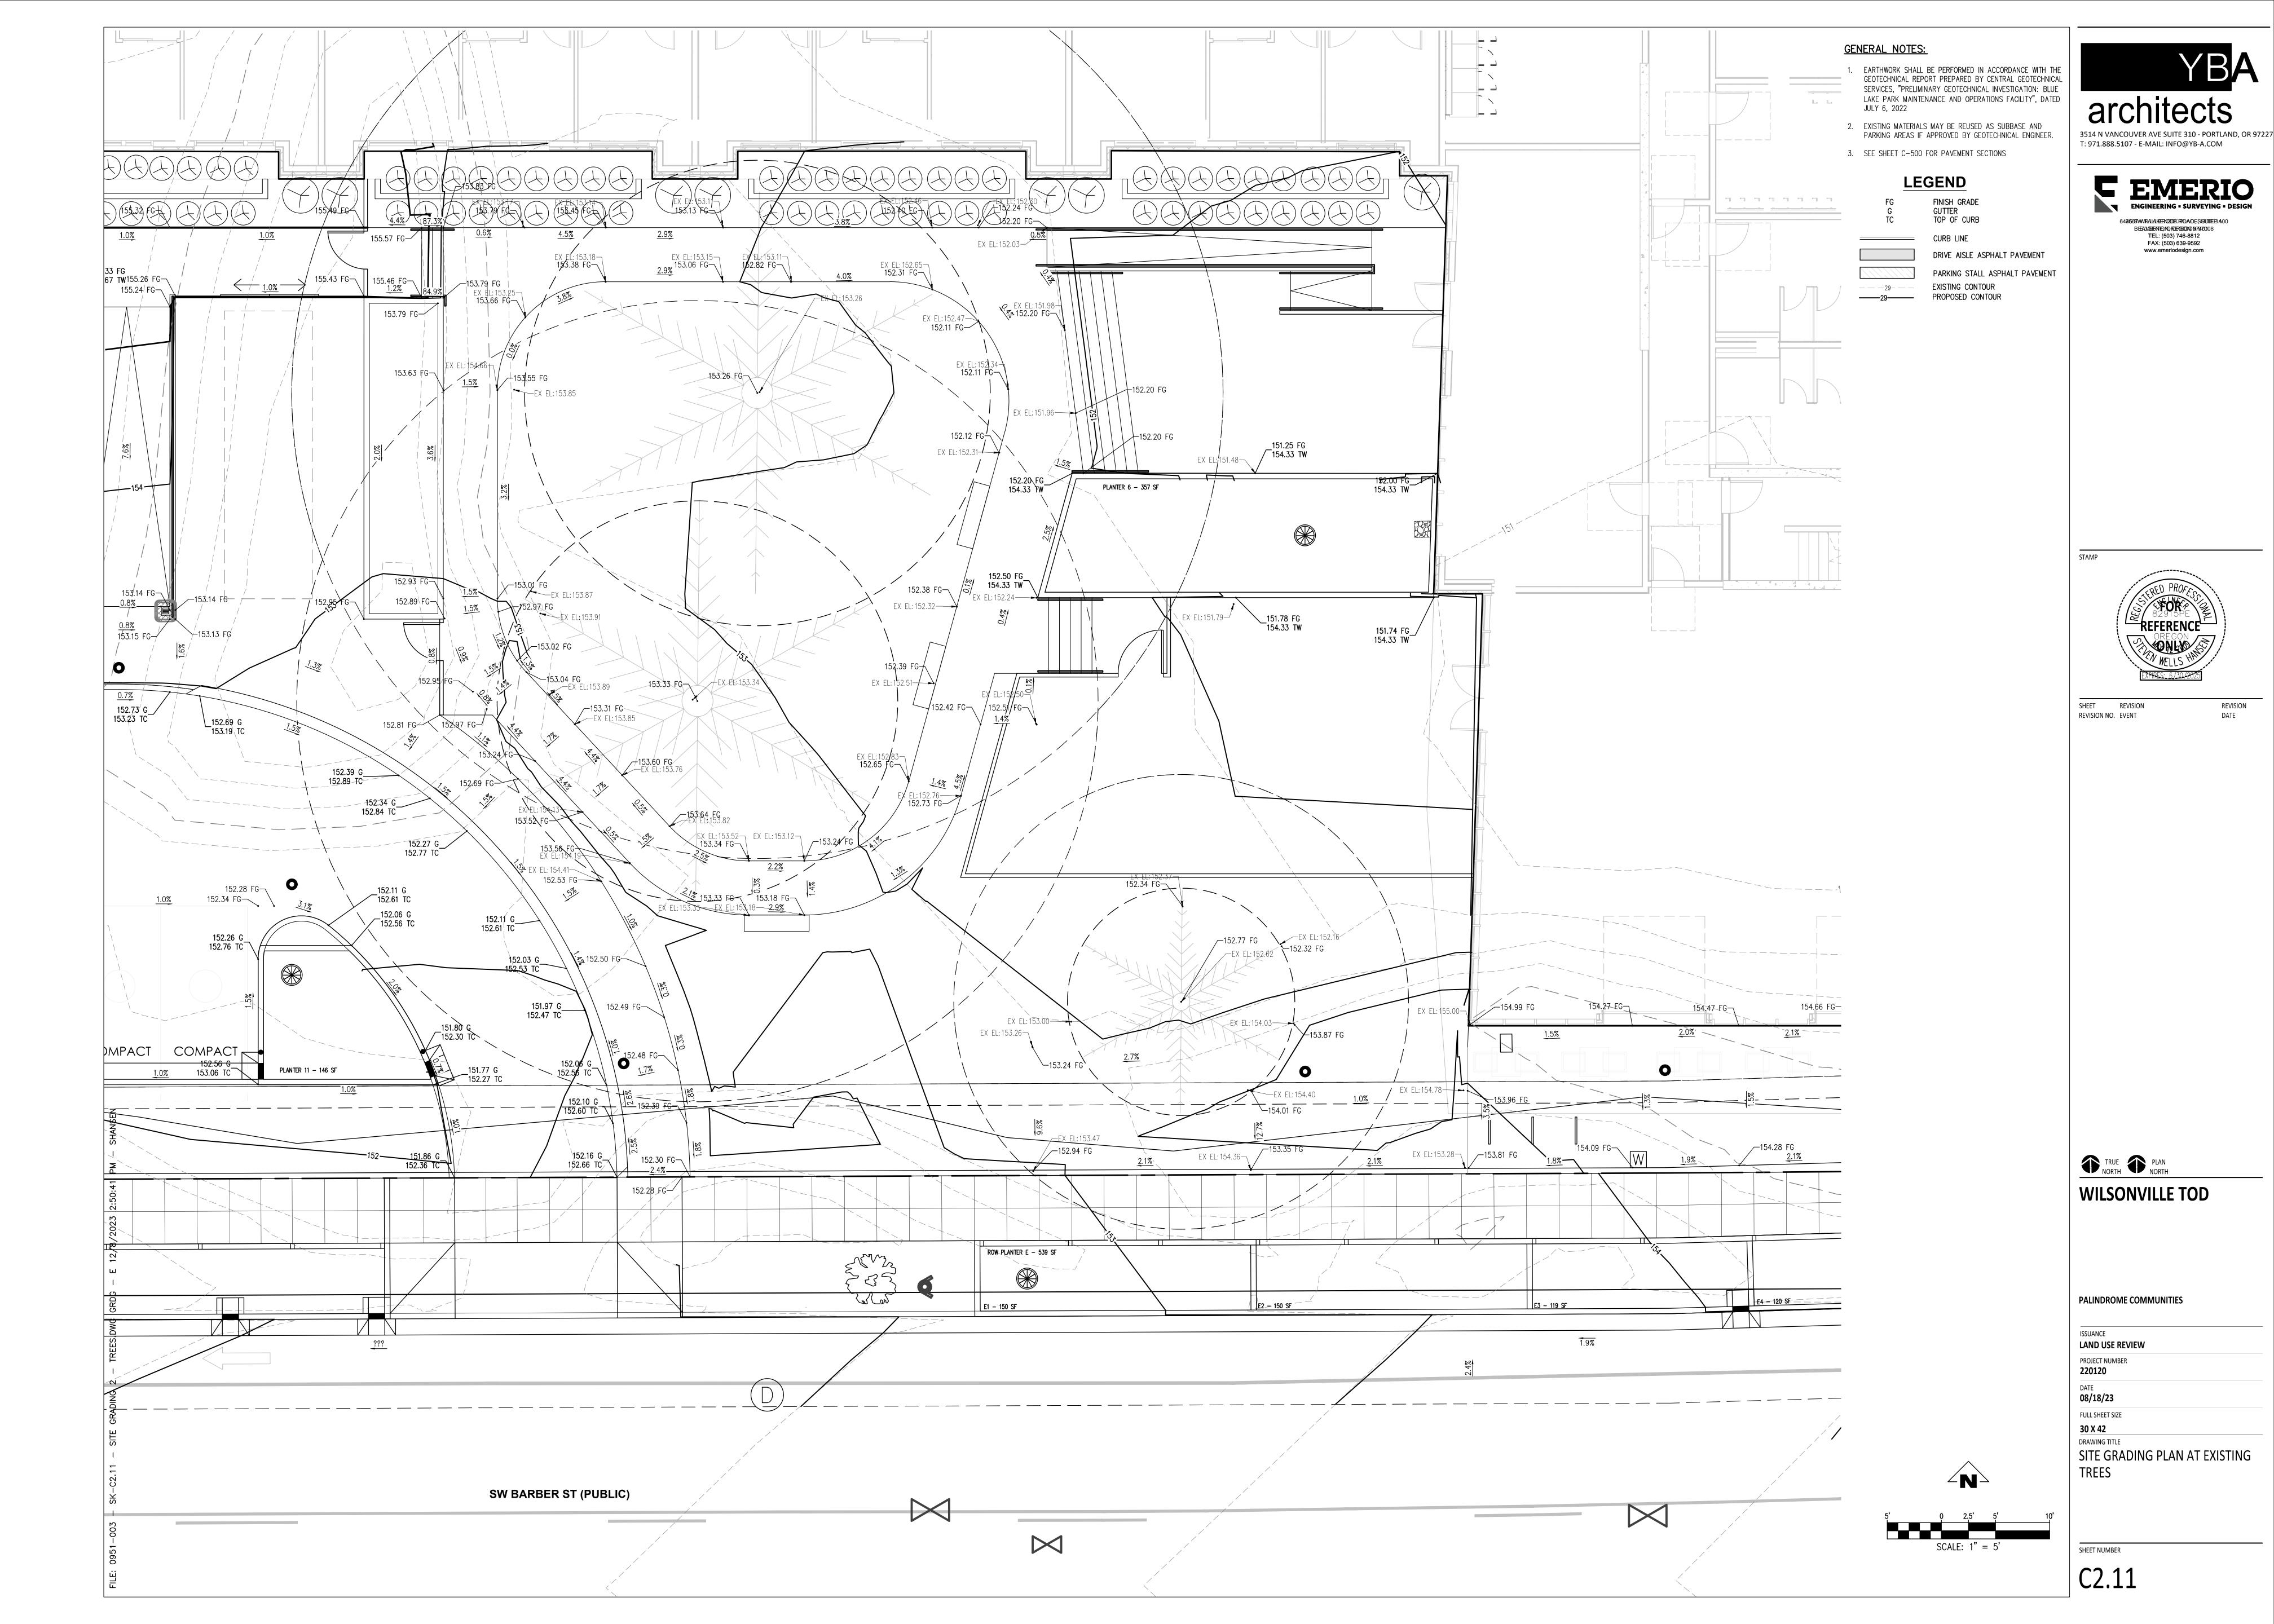

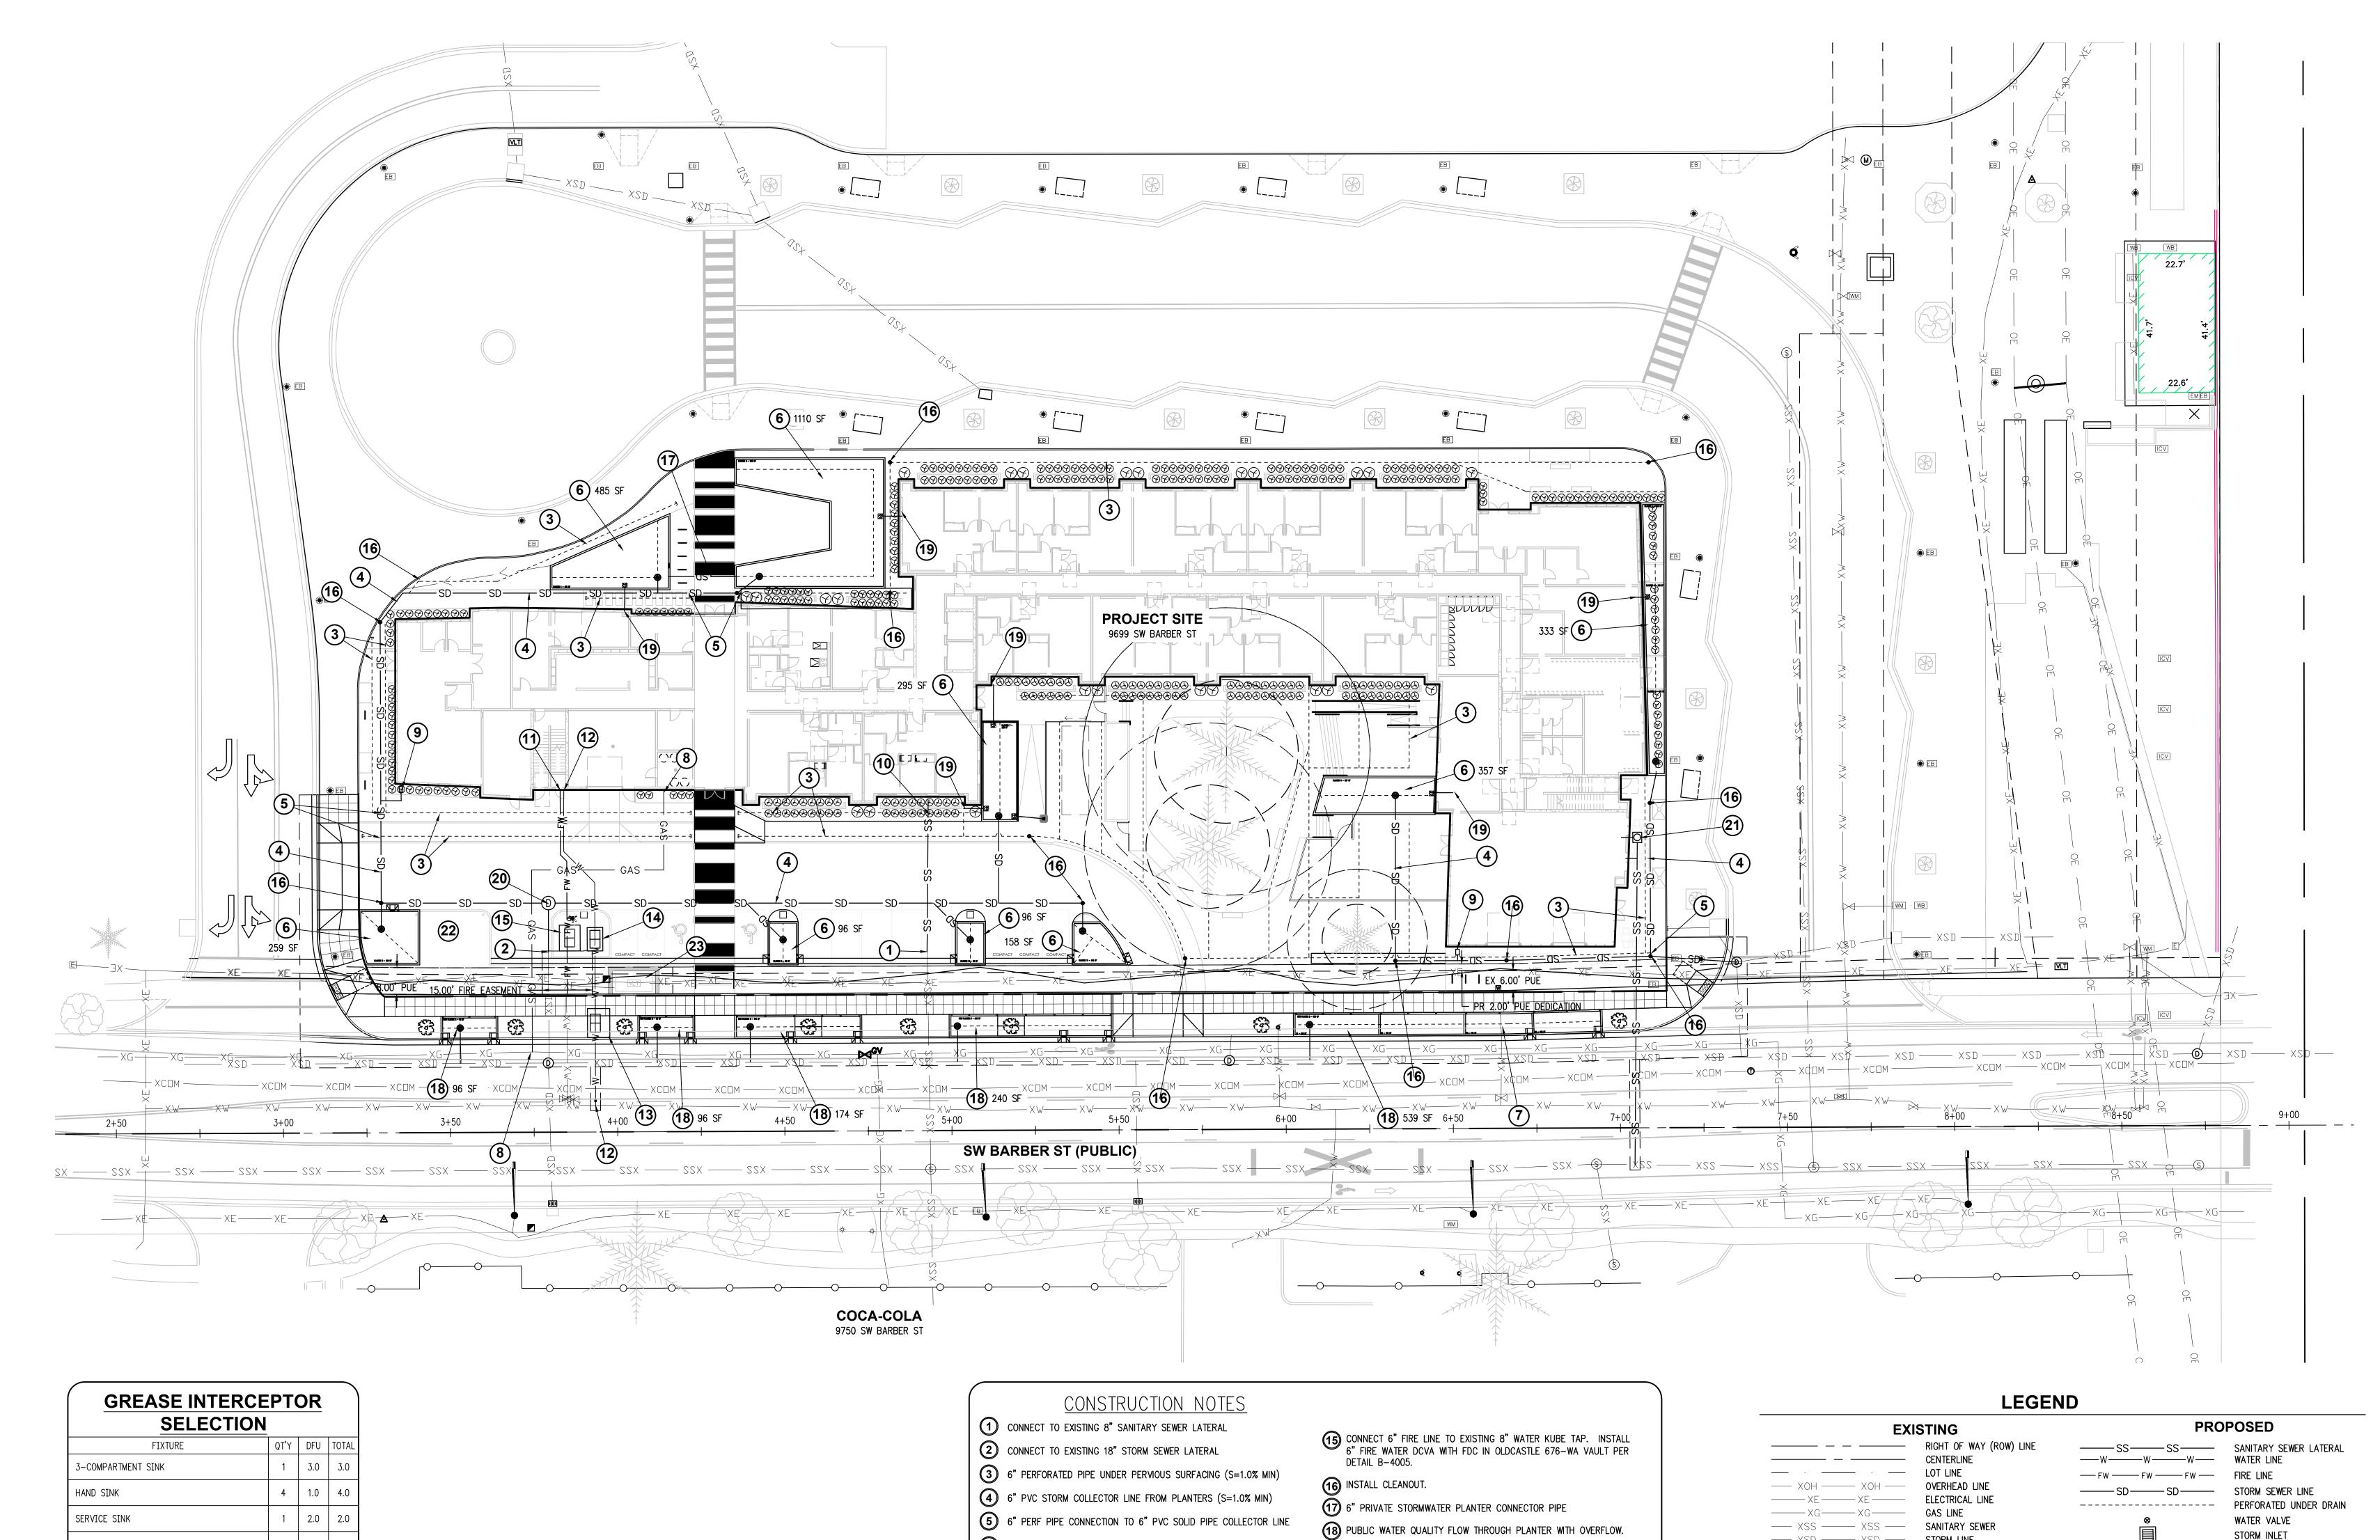


	EX	ISTING
		RIGHT OF WAY (ROW) LINE
		CENTERLINE
	·	LOT LINE
—— XOH ——	— ХОН ——	OVERHEAD LINE
——— XE ——	XE	ELECTRICAL LINE
——————————————————————————————————————	—— XG———	GAS LINE
— XSS —	— XSS —	SANITARY SEWER
—— XSD ——	— XSD —	STORM LINE
XW	XW	WATER LINE
XCOM	XCOM	COMM LINE
		FENCE LINE
		CURB
0		SIGN
	-0_	LITILITY/LIGHT POLF

WATER LINE COMM LINE FENCE LINE CURB SIGN
UTILITY/LIGHT POLE
VALVE BOX

STORM SEWER MANHOLE

\bowtie	VALVE BOX
•	FIRE HYDRANT
(1)	COMM MANHOLE
S	SANITARY SEWER MANHOLE
Ш	STORM INLET

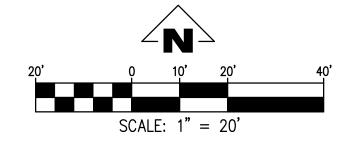

CLEANOUT

BEEHIVE OVERFLOW

TRUE PLAN NORTH

REVISION NO. EVENT

WILSONVILLE TOD

architects

BEAUCEENE, NO REFERENCE DID 1917/91/2010 8 TEL: (503) 746-8812 FAX: (503) 639-9592

T: 971.888.5107 - E-MAIL: INFO@YB-A.COM

PALINDROME COMMUNITIES

AND USE REVIEW	
PROJECT NUMBER	
220120	
DATE	
08/18/23	
FULL SHEET SIZE	
30 X 42	

DRAWING TITLE UTILITY PLAN

SHEET NUMBER

C3.00

FLOOR DRAIN 3 | 2.0 | 6.0 1 0.5 0.5 MOP SINK DISHWASHER 1 2 2.0 TOTAL DFU | 17.5 8 DFUs = 20 GPM GREASE INTERCEPTOR

10 DFUs = 25 GPM GREASE INTERCEPTOR 13 DFUs = 35 GPM GREASE INTERCEPTOR 20 DFUs = 50 GPM GREASE INTERCEPTOR 35 DFUS = 75 GPM GREASE INTERCEPTOR

6 CONSTRUCT PRIVATE FILTRATION PLANTER WITH PERFORATED 4" PVC PIPE PER CITY OF WILSONVILLE STANDARD DETAIL ST-6005 REROUTE EXISTING 1.5-INCH WATER LINE UNDER PROPOSED STORMWATER PLANTER AND PROVIDE LINEAR ADJUSTMENT OF METER

FOR LANDSCAPE IRRIGATION. SEE LANDSCAPE PLANS FOR

CONTINUATION

(8) NATURAL GAS CONNECTION 9 INSTALL 3" NDS BACKWATER VALVE IN OLDCASTLE VALVE BOX PER DETAILS ON SHEET C7.06. INSTALL 3" PERFORATED FOOTING DRAIN PIPE PER STRUCTURAL DETAILS AND GEOTECHNICAL REPORT

8" ASTM D 3034 PVC SANITARY SEWER. S=1.0% MIN

6" FIRE LINE CONNECTION

4" DOMESTIC WATER LINE CONNECTION

4" WATER METER IN OLDCASTLE 687—WA VAULT PER CITY OF WILSONVILLE DETAIL WT—3110.

4" DOMESTIC WATER DOUBLE CHECK BACK FLOW PREVENTOR DEVICE IN OLDCASTLE 577-LA VAULT PER DETAIL B-4005

ROOF DRAIN CONNECTION


20 INSTALL 48" DIA MH WITH 18" OUTFALL PIPE.

INSTALL 50 GPM GREASE INTERCEPTOR, SCHIER MODEL "GB-50" OR APPROVED EQUAL. ONLY FIXTURES LISTED IN THE GREASE INTERCEPTOR SELECTION TABLE WILL BE ROUTED TO THE GREASE INTERCEPTOR, ALL OTHER FIXTURES WILL BE CONNECTED DIRECTLY TO SEWER LATERAL. RISERS MAY NOTE EXCEED 12", IF RISERS EXCEED 12" A VAULT MUST BE PROVIDED. RISERS FOR THE GREASE INTERCEPTOR MAY NOT EXCEED 12

INCHES IN HEIGHT 22) PGE TRANSFORMER

EXISTING PGE SWITCH VAULT TO REMAIN AND BE PROTECTED.

CONSTRUCT KEYSTONE RETAINING WALL AROUND EXISTING VAULT TO MAINTAIN EXISTING GRADE

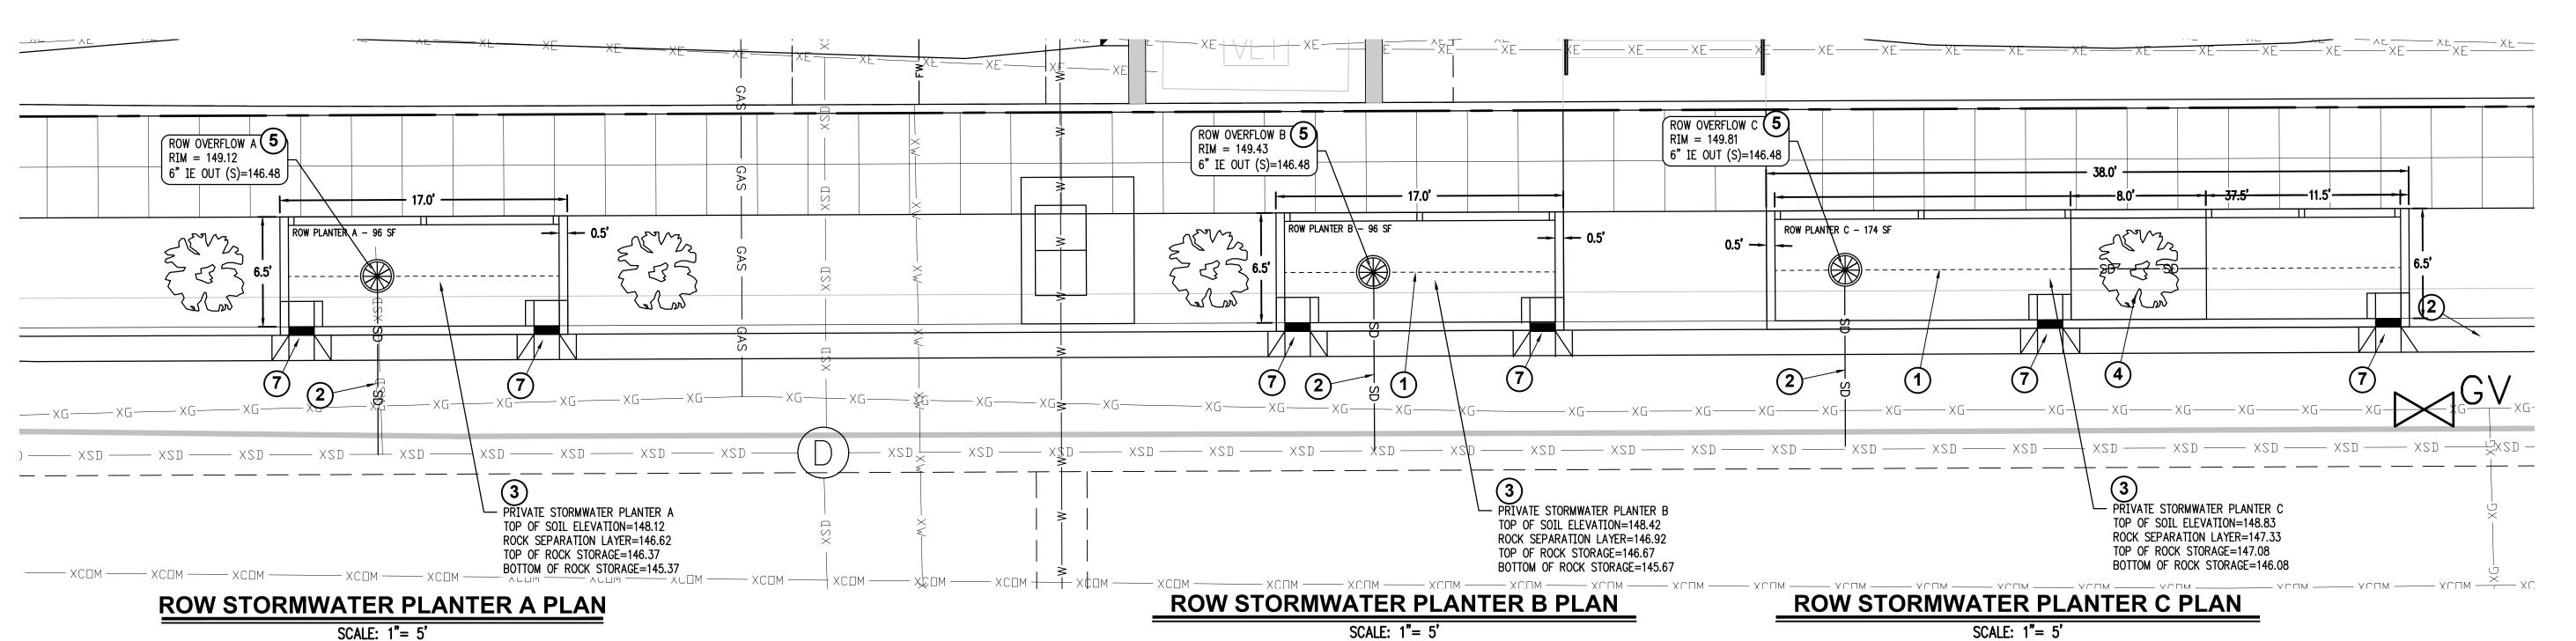

ROW OVERFLOW 5
RIM = 150.62 ___ 6" IE OUT (S)=146.48

ROW PLANTER D - 240 SF


CONSTRUCTION	NOTE:

- 6" PERFORATED PIPE UNDERDRAIN (S=1.0% MIN)
- 6" PVC STORM LINE FROM PLANTERS (S=1.0% MIN)
- PUBLIC WATER QUALITY FLOW THROUGH PLANTER WITH OVERFLOW AND PERFORATED 4" PVC PIPE PER CITY OF WILSONVILLE STANDARD DETAIL ST-6005
- STREET TREE IN ROW PLANTER PER DETAIL ON SHEET C5.03
- BEEHIVE FLOW CONTROL STRUCTURE PER CITY OF WILSONVILLE STD DWG ST-6120. SEE DETAIL ON SHEET C5.03
- 6 4" DRAINAGE NOTCH
- 7 SWALE INLET PER STD DWG ST-6012
- 8 CHECK DAM
- 9 RE-ROUTE 1.5" IRRIGATION WATER SERVICE LINE UNDERNEATH STORMWATER PLANTER

STORMWATER PL			
PLANTER NUMBER	DRAINAGE BASIN (SF)	FACILITY SIZE (SF)	ORIFICE SIZE (IN)
PLANTER A	694	96	0.2
PLANTER B	1,366	96	0.4
PLANTER C	2,457	174	.05
PLANTER D	3,272	229	0.5
DI ANTED E	7.650	F70	0.0

PLANTER NUMBER	DRAINAGE BASIN (SF)	FACILITY SIZE (SF)	ORIFICE SIZE (IN)
PLANTER A	96	0.2	
PLANTER B	1,366	96	0.4
PLANTER C	2,457	174	.05
PLANTER D	3,272	229	0.5
PLANTER E	7,659	539	0.8

STORMWATER	R PLANTER	MEDIA DEPTH	l DATA		
PLANTER NUMBER GROWING ROCK SEPARATION ROCK STORAGE MEDIUM (IN) LAYER (IN) DEPTH (IN)					
PLANTER A	18"	3"	12"		
PLANTER B	18"	3"	12"		
PLANTER C	18"	3"	12"		
PLANTER D	18"	3"	12"		
PLANTER E	18"	3"	VARIES (12" MIN)		

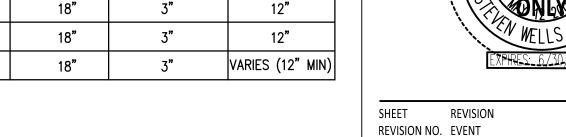

ABBREVIATIONS


- G = GUTTER OR PROJECTED GUTTER ELEVATION DG = DEPRESSED GUTTER ELEVATION
- DN = DRAINAGE NOTCH ELEVATION
- FG = FINISHED GRADE ELEVATION PLANTER SW = FINISHED GRADE SIDEWALK ELEVATION
- TW = TOP OF WALL ELEVATIONTC = TOP OF CURB OR PROJECTED CURB ELEVATION

— ХСДМ — — ХСДМ ______ XCПМ _____ XСПМ _____ XСПМ _____ XСПМ _____ XСПМ ____ XСПМ ____ XСПМ ____ XСПМ ____ XСПМ ____ XСПМ ____ ROW STORMWATER PLANTER D PLAN

— PRIVATE STORMWATER PLANTER D
TOP OF SOIL ELEVATION=149.63


ROCK SEPARATION LAYER=148.13 TOP OF ROCK STORAGE=147.88 BOTTOM OF ROCK STORAGE=146.88

SCALE: 1"= 5'

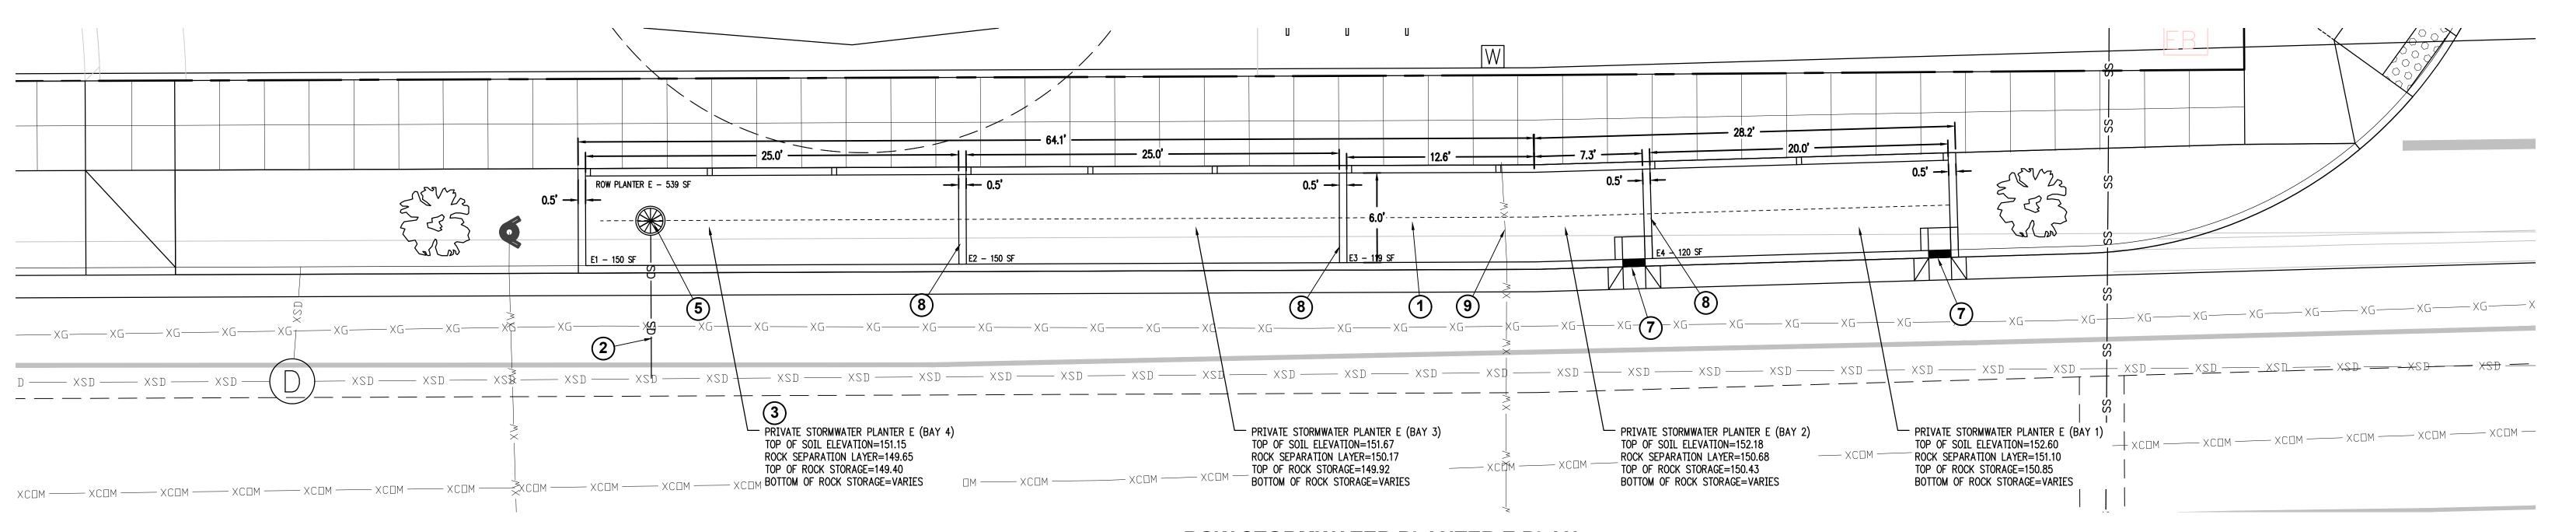

ROW STORMWATER PLANTER E PLAN

SCALE: 1"= 5'

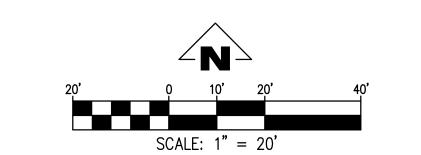



WILSONVILLE TOD

T: 971.888.5107 - E-MAIL: INFO@YB-A.COM

BEAUCERNE NO REPRESONO 1979/10008 TEL: (503) 746-8812 FAX: (503) 639-9592

www.emeriodesign.com

REVISION

DATE

PALINDROME COMMUNITIES

LAND USE REVIEW


PROJECT NUMBER

220120 08/18/23

FULL SHEET SIZE 30 X 42

DRAWING TITLE ROW STORMWATER PLANTERS

C3.13

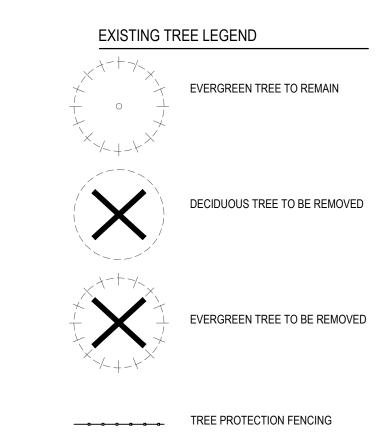

SYMBOL	DESCRIPTION	DBH	ACTION	CONDITION	TREE CREDITS	HEALTH
T-01	ZELKOVA SERRATA	11"	REMOVE	<u> </u>		GOOD
T-02	PRUNUS AVIUM	15"	REMOVE	NUISANCE		GOOD
T-03	PSEUDOTSUGA MENZIESII	12"	REMOVE			EXCELLENT
T-04	PINUS RESINOSA	10"	REMOVE			FAIR
T-05	PSEUDOTSUGA MENZIESII	21"	PROTECT	2-FOOT LOWER THAN SIDEWALK	3 CREDITS	EXCELLENT
T-06	ZELKOVA SERRATA	9"	REMOVE	CENTER STEM DE	EAD	FAIR
T-07	ZELKOVA SERRATA	12"	REMOVE	LOW CANOPY		EXCELLENT
T-08	ZELKOVA SERRATA	11"	REMOVE	LOW CANOPY		EXCELLENT
T-09	ZELKOVA SERRATA	11"	REMOVE	LOW CANOPY		EXCELLENT
T-10	ZELKOVA SERRATA	12"	REMOVE	LOW CANOPY		POOR
T-11	ZELKOVA SERRATA	12"	REMOVE	LOW CANOPY		GOOD
T-12	ZELKOVA SERRATA	9"	REMOVE			EXCELLENT
T-13	PSEUDOTSUGA MENZIESII	14"	REMOVE	SAP OOZE		GOOD
T-14	CRATAEGUS MONOGYNA	15"	REMOVE	80% CROWN DIE	BACK	VERY POOF
T-15	PSEUDOTSUGA MENZIESII	10"	REMOVE			EXCELLENT
T-16	PINUS RESINOSA	15"	REMOVE	CODOMINATE AT	3`	GOOD
T-17	ZELKOVA SERRATA	7"	REMOVE	30% CROWN DIE	BACK	FAIR
T-18	PSEUDOTSUGA MENZIESII	13"	REMOVE	SNOW/ ICE DAMA	GED BRANCHES	GOOD
T-19	PSEUDOTSUGA MENZIESII	9"	REMOVE	SNOW/ ICE DAMA	GED BRANCHES	GOOD
T-20	ZELKOVA SERRATA	10"	REMOVE	TWIG DIE BACK		GOOD
T-21	ZELKOVA SERRATA	8"	REMOVE			GOOD
T-22	PSEUDOTSUGA MENZIESII	12"	REMOVE			GOOD
T-23	ZELKOVA SERRATA	10"	REMOVE			GOOD
T-24	ACER PLATANOIDES	19"	REMOVE	LEANING		GOOD
T-25	CRATAEGUS MONOGYNA	8"	REMOVE	DEAD		DEAD
T-26	PSEUDOTSUGA MENZIESII GOOD	37"	PROTECT	DEAD WOOD IN CROWN	5 CREDITS	
T-27	PSEUDOTSUGA MENZIESII GOOD	43	PROTECT	DEAD WOOD IN CROWN	5 CREDITS	

EXISTING TREE SCHEDULE

TREE PROTECTION NOTES

- A. PROTECT ALL TREES INDICATED TO REMAIN, INCLUDING BARK AND ROOT ZONES.
- B. FENCING SHALL BE INSTALLED PER THE TREE PROTECTION PLAN. FINAL LAYOUT SHALL BE REVIEWED AND APPROVED BY THE PROJECT ARBORIST AND/OR LANDSCAPE ARCHITECT.
- C. ALL WORK WITHIN THE TREE PROTECTION ZONE SHALL BE PERFORMED WITH HANDHELD TOOLS OR AIR SPADE.
 D. EXCAVATION WITHIN THE TREE PROTECTION ZONE SHALL BE PERFORMED WITH HANDHELD TOOLS OR AIR SPADE. EXCAVATE THE MINIMUM AMOUNT NECESSARY TO ACCOMPLISH PURPOSE FOR EXCAVATION. ROOTS OVER 4" DIAMETER SHALL BE CUT BY THE PROJECT ARBORIST.
- E. THE FOLLOWING IS PROHIBITED WITHIN THE ROOT PROTECTION ZONE OF EACH TREE OR OUTSIDE THE LIMITS OF THE DEVELOPMENT IMPACT AREA:
 GROUND DISTURBANCE OR CONSTRUCTION ACTIVITY INCLUDING VEHICLE OR EQUIPMENT ACCESS (BUT EXCLUDING
- GROUND DISTURBANCE OR CONSTRUCTION ACTIVITY INCLUDING VEHICLE OR EQUIPMENT ACCESS (BUT EXCLUDING ACCESS ON EXISTING STREETS OR DRIVEWAYS)
 STORAGE OF EQUIPMENT OR MATERIALS INCLUDING SOIL, TEMPORARY OR PERMANENT STOCKPILING, PROPOSED
- STORAGE OF EQUIPMENT OR MATERIALS INCLUDING SOIL, TEMPORARY OR PERMANENT STOCKPILING, PROPOSED BUILDINGS, IMPERVIOUS SURFACES, UNDERGROUND UTILITIES, EXCAVATION OR FILL, TRENCHING OR OTHER WORK

 ACTIVITIES.
- ACTIVITIES

 E. PROTECTIVE FENCE SHALL BE INSTALLED BEFORE ANY GROUND DISTURBING ACTIVITIES INCLUDING CLEARING AND GRADING, OR CONSTRUCTION STARTS; AND SHALL REMAIN IN PLACE UNTIL FINAL INSPECTION.
- F. SIGNAGE DESIGNATING THE PROTECTION ZONE AND PENALTIES FOR VIOLATIONS SHALL BE SECURED IN A PROMINENT LOCATION ON EACH PROTECTION FENCE.
- G. TREE PROTECTION ZONE SHALL REMAIN FREE OF ALL CHEMICALLY INJURIOUS MATERIALS AND LIQUIDS.

MAINTENANCE NOTES FOR EXISTING TREES


- A. WASH OFF FOLIAGE WHICH BECOMES SOILED DURING CONSTRUCTION.

 B. WATER TREES AND OTHER VEGETATION WHICH ARE TO REMAIN AS NECESSARY TO MAINTAIN THEIR HEALTH DURING THE
- COURSE OF THE WORK. RATE AND FREQUENCY OF APPLICATION TO BE DETERMINED BY PROJECT ARBORIST.

 C. ALL PRUNING SHALL BE PERFORMED BY A CURRENT ARBORIST LICENSED WITHIN THE STATE/COUNTY/CITY WHERE THE WORK IS TO BE COMPLETED.





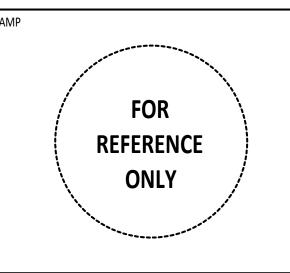

SHEET REVISION
REVISION NO. EVENT

DATE



PALINDROME COMMUNITIES


ISSUANCE
LAND USE REVIEW
PROJECT NUMBER
220120
DATE
08/18/23


DRAWING TITLE

EXISTING TREE INVENTORY PLAN

SHEET NUMBER



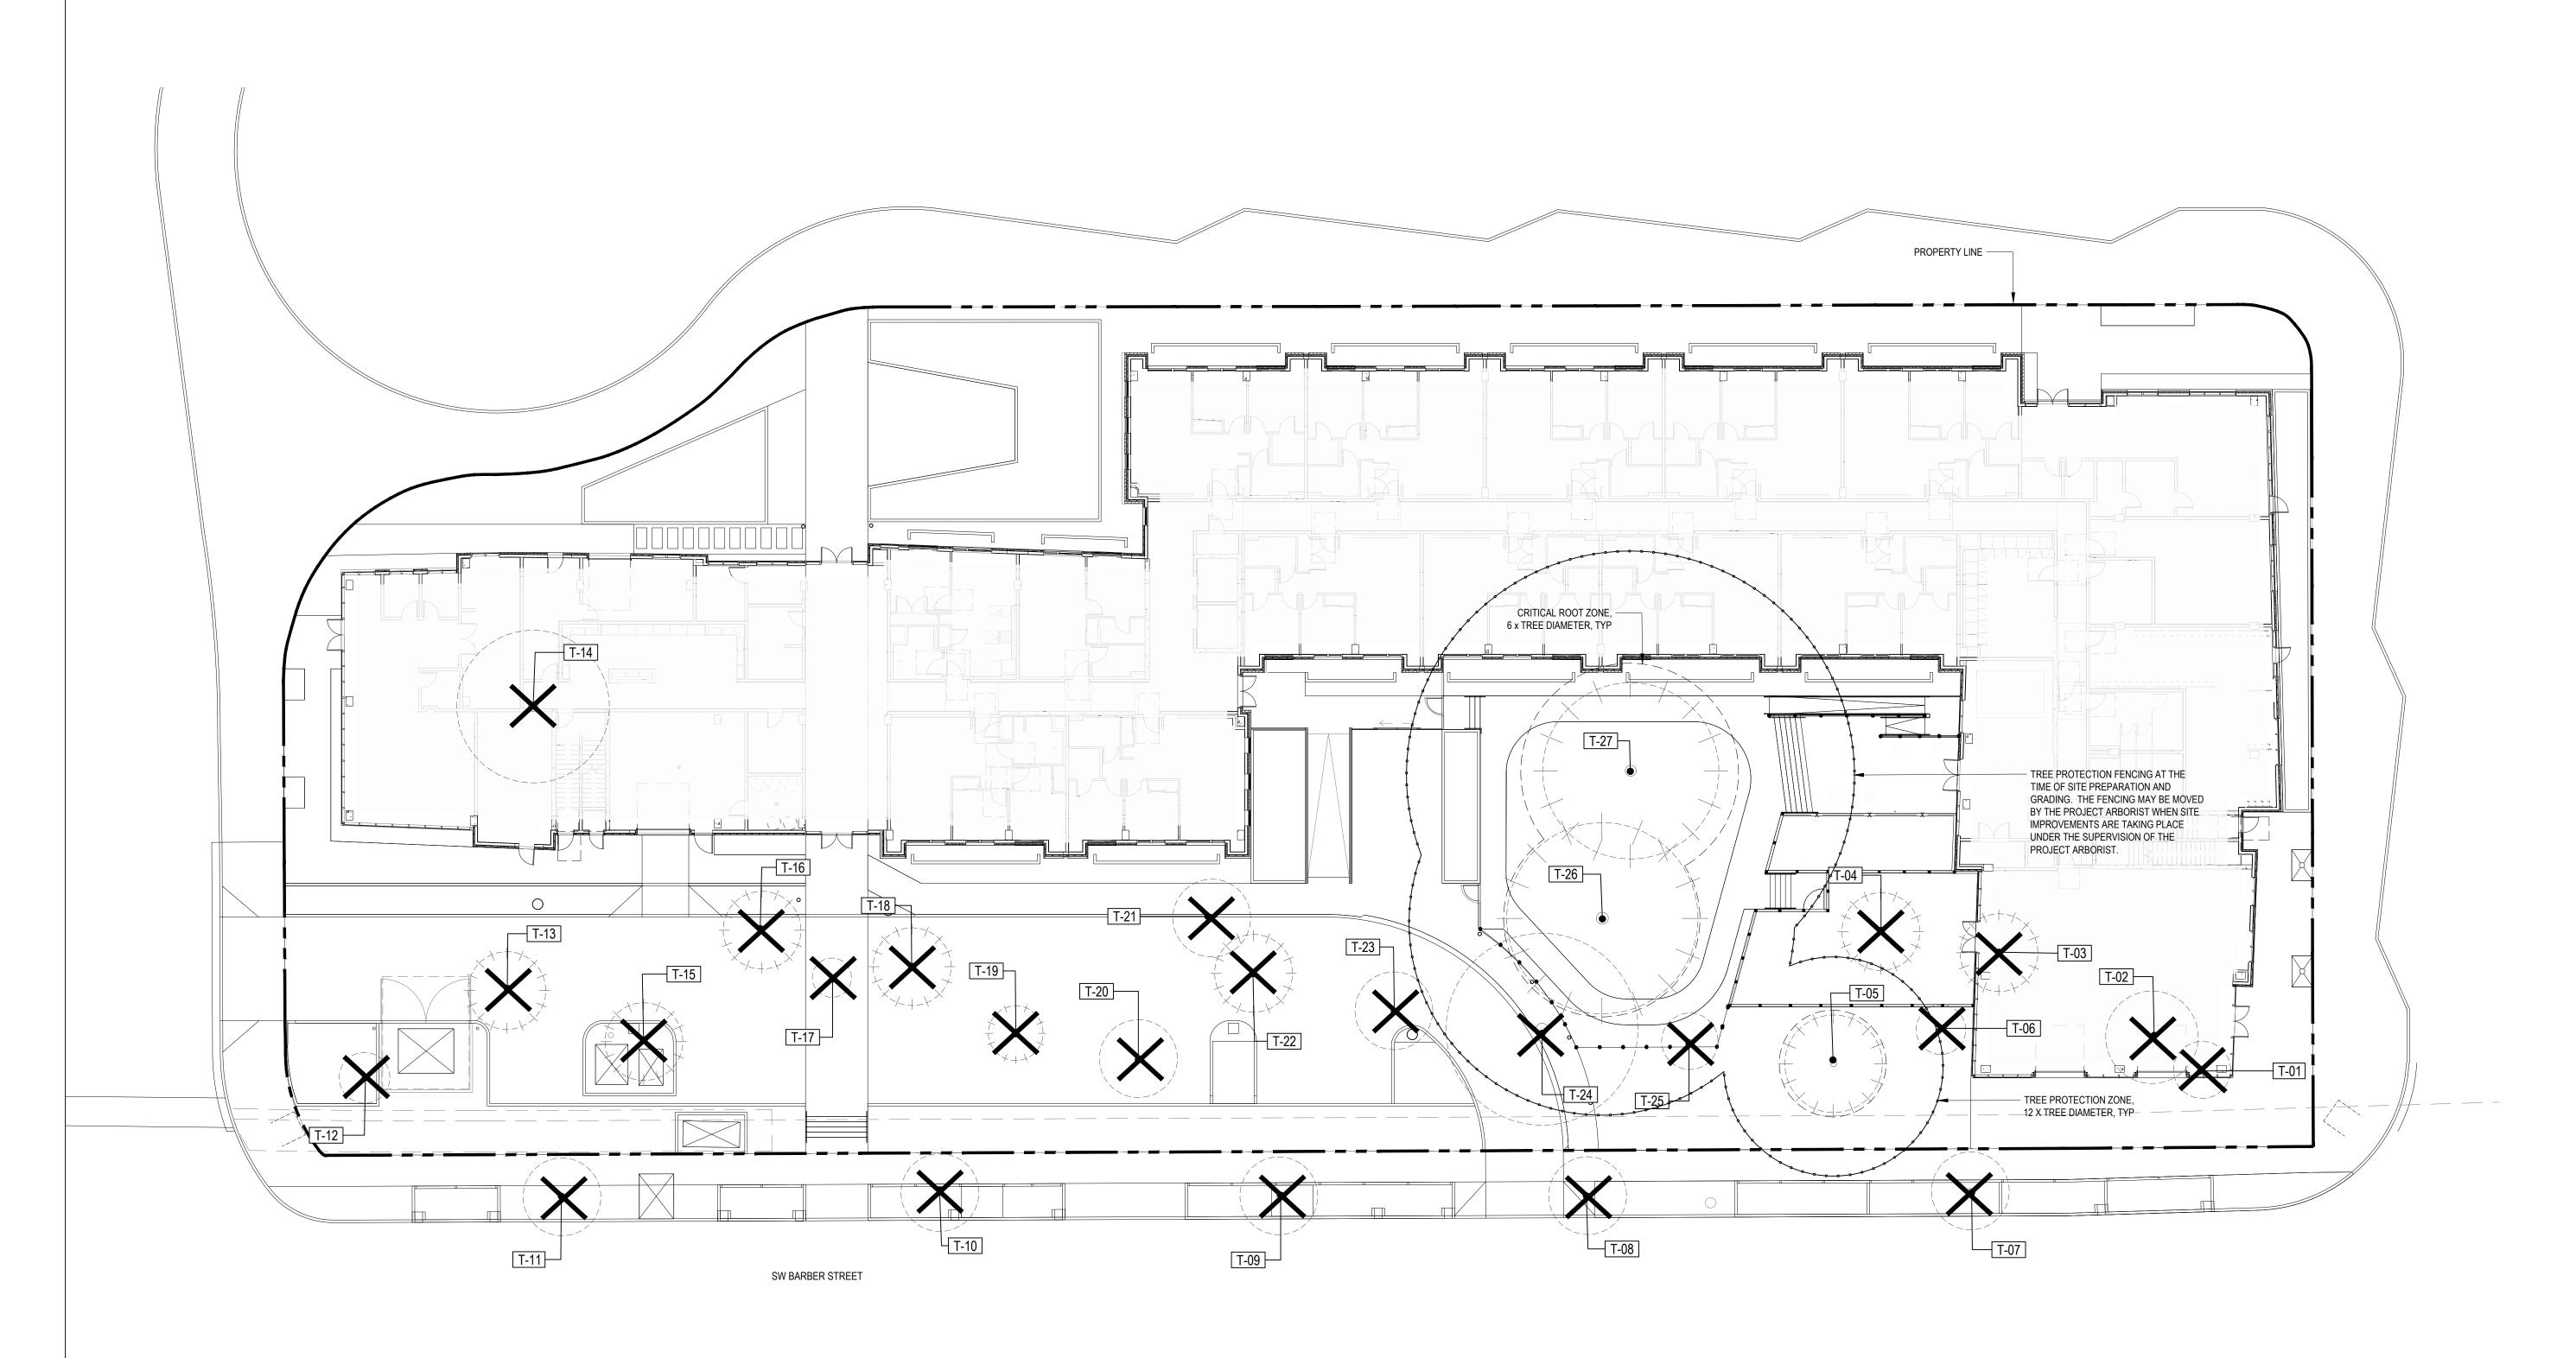

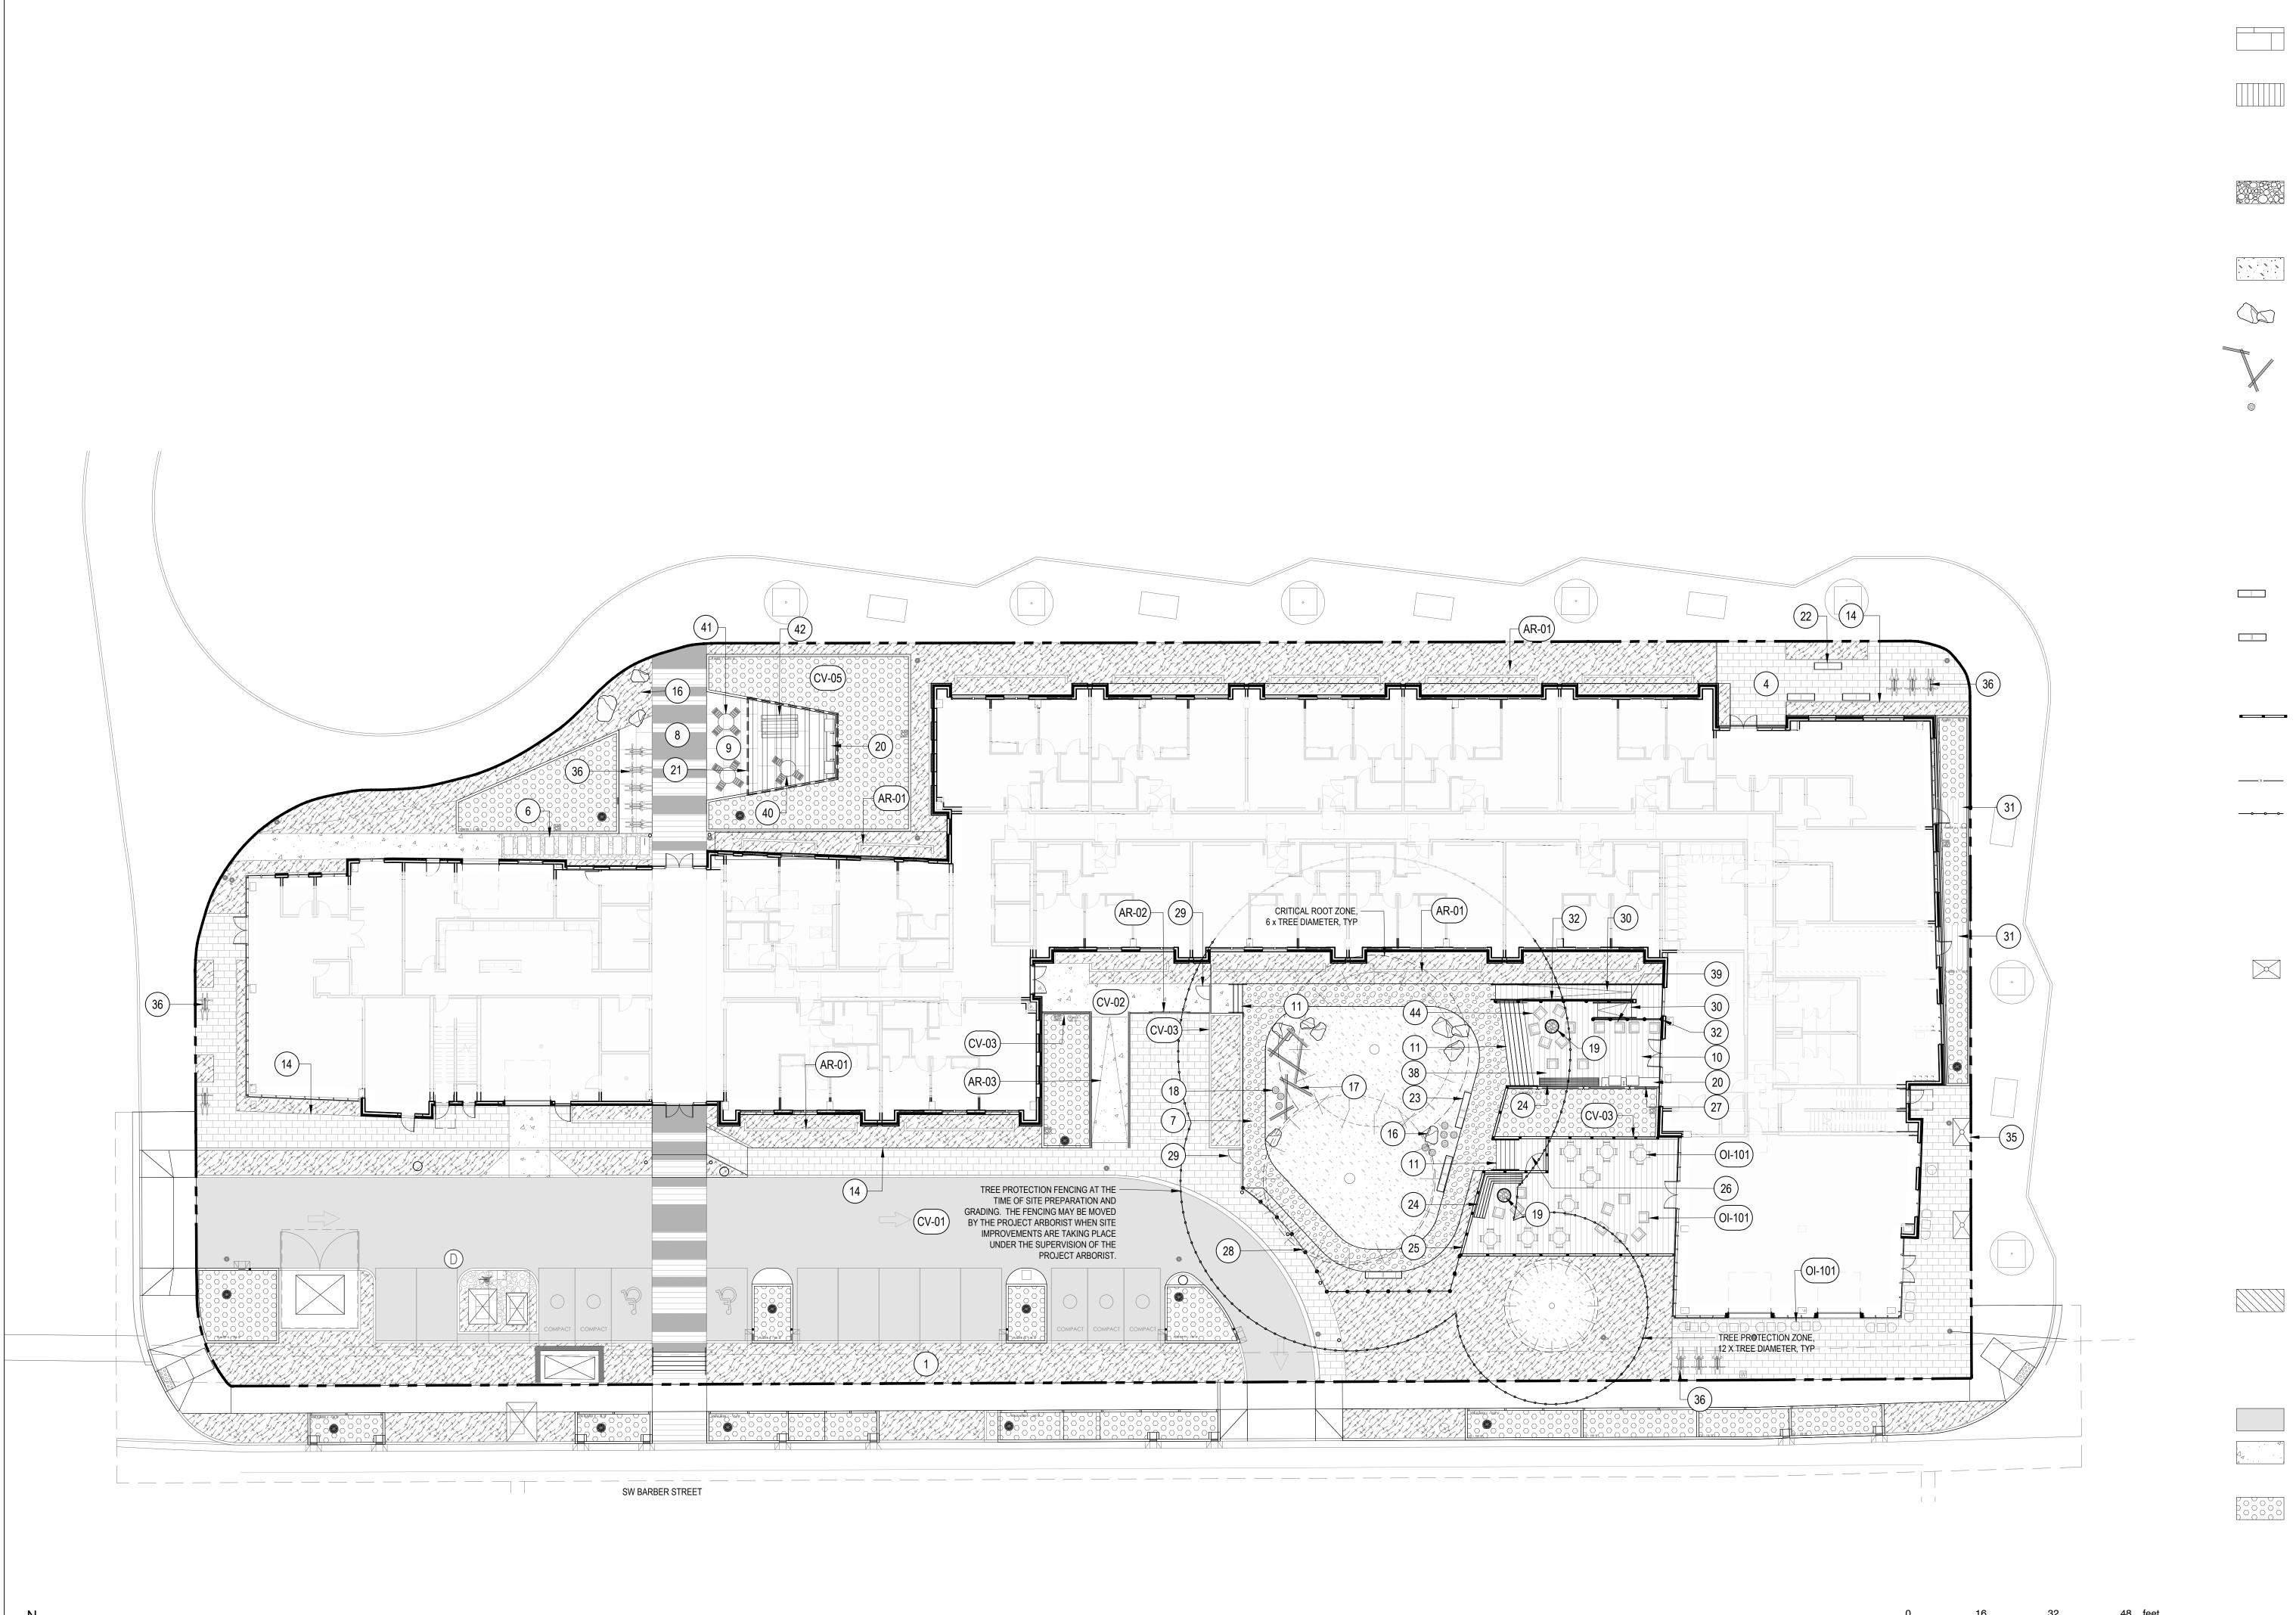

LEVEL 1 MATERIALS PLAN

architects

3514 N VANCOUVER AVE SUITE 310 - PORTLAND, OR 97227
T: 971.888.5107 - E-MAIL: INFO@YB-A.COM

REFERENCE NOTES SCHEDULE

DESCRIPTION

PLANTING AREA, TYP.

PAVER TYPE III

PAVER TYPE I - PERMEABLE BELGARD AQUALINE 3x12 COLOR: DARK CHARCOAL

WAUSAU TILE EXPRESSIONS 24x48 COLOR: DARK CHARCOAL

CONCRETE SURFACING TYPE II ETCHED / STAMPED CONCRETE

CONCRETE SURFACING TYPE III EXPOSED AGGREGATE SURFACING

CEDAR OR THERMALLY MODIFIED WOOD CONCRETE CAST-IN-PLACE FOOTINGS OR HELICAL PIER AND DECK FOOTING

POST AND BEAM DECKING,

SUPPORT SYSTEM TBD

STAIRS TO MATCH DECKING

3/4-INCH GRAY RIVER COBBLE

METAL EDGE RESTRAINT

LANDSCAPE BOULDERS

LOG SCRAMBLE TIMBERS

LOG ROUND

FIRE TABLE, TYP.

POLIGON TRELLIS

CAMAS GRAY BASALT, ANGULAR APPEARANCE

WEATHERIZED LOGS PINNED TOGETHER AND TO GROUND

WEATHERIZED 16-18 INCH ROUND LOG PLACED ON END

SEE ELECTRICAL DRAWINGS FOR ELECTRICAL HOOKUP

SEE ELECTRICAL DRAWINGS FOR ELECTRICAL HOOKUP

KNOTWOOD ALUMINUM FENCE; SQ. BLACK POSTS, 4" WIDE,

6.5' TALL KNOTWOOD ALUMINUM FENCE; 4" SQ. POSTS WITH 6" WIDE, HORIZONTAL SLATS, WOODGRAIN COLORED

4' DECORATIVE METAL PICKET GATE WITH RESIDENT PASS-KEY MECHANISM, POWDER-COATED BLACK

CEDAR OR THERMALLY MODIFIED WOOD PLANK BRIDGE

42" RAILPRO CONTEMPORARY SQUARE PICKET RAILING,

WOOD DECK RAMP ON STEEL FRAME, NON-SLIP

ON STEEL FRAME; BLACK METAL RAILINGS

HUNTCO RAMBLER - FLAT PROFILE, BLACK

LANDSCAPE FORMS 28" SQUARE PARK CENTRE

LANDSCAPE FORMS HARPO 24" BACKED BENCH -STEEL FRAME / WIDE WOOD SLATS, EXTERIOR FINISH

DUMOR 42" ROUND STEEL ADA TABLE WITH THREE ATTACHED SEATS - COLOR TBD

DUMOR 42" ROUND STEEL TABLE WITH FOUR ATTACHED SEATS - COLOR TBD

DUMOR 6' ALUMINUM PICNIC TABLE WITH

LANDSCAPE FORMS HARPO LOUNGE CHAIR

SEE ARCHITECTUAL DRAWINGS / DETAILS / SPECS

ATTACHED BENCHES - COLOR TBD

- STEEL FRAME WITH WOOD SLATS

METAL FENCE & MOVEABLE GATES

CONCRETE RAMP AND HANDRAILS

CONCRETE SURFACING TYPE I

RAISED CONCRETE PLANTER

SEE LANDSCAPE FOR PLANTINGS SEE CIVIL DRAWINGS / DETAILS / SPECS

FOR ADDITIONAL INFORMATION

MOVEABLE TABLE & CHAIRS

OWNER FURNISHED, OWNER INSTALLED

STORMWATER AREA, TYP.

DESCRIPTION

SEE CIVIL DRAWINGS / DETAILS / SPECS

DESCRIPTION

DESCRIPTION

ASPHALT PAVING

18" CONCRETE WALL, TYP

SEE ARCHITECTURE

WOODGRAIN COLORED, VERTICAL SLATS, W / 4" GAPS
KNOTWOOD ALUMINUM FENCE; GATE TO MATCH FENCE,
ONE-WAY OPEN WITH INTERIOR LOCKING MECHANISM

SEE CIVIL DRAWINGS FOR PROPANE HOOK UP

THERMALLY MODIFIED WOOD CLADDING;

CEDAR LATILLA ON STEEL FRAME

FIR LOG BENCH 24" DIA. 6-FOOT LONG

FIR LOG BENCH 24" DIA. 8-FOOT LONG

4' DECORATIVE METAL PICKET FENCE

POWDER-COATED BLACK

PAINT, TUBE STEEL HANDRAILS

TREE GRATE

BIKE RACK

CITY STANDARD 4' X 6'

BENCH, COLOR TBD

35

SYMBOL

SYMBOL

CUSTOM CORNER BENCH, CEDAR SLATS ON METAL FRAME

SEE CIVIL DRAWINGS FOR PROPANE HOOKUP

BBQ ENCLOSURE - CONCRETE COUNTER TOP AND

4" MULCH TYPE II CEDAR PLAY CHIPS

PAVER TYPE IV - GEO-GRID WITH GRAVEL

SEE LANDSCAPE DRAWINGS / DETAILS / SPECS

SYMBOL

6



FOR REFERENCE ONLY

REVISION

DATE

SHEET REVISION

REVISION NO. EVENT

TRUE NORTH

PLAN NORTH

WILSONVILLE TOD

PALINDROME COMMUNITIES

ISSUANCE
LAND USE REVIEW

PROJECT NUMBER
220120

DATE
08/18/23

FULL SHEET SIZE
30 X 42

LEVEL 1 MATERIALS PLAN

SHEET NUMBER

DRAWING TITLE

12

SCALE: 1/16" = 1'-0"





REFERENCE

REVISION DATE

SHEET REVISION REVISION NO. EVENT

TRUE PLAN NORTH

PALINDROME COMMUNITIES


WILSONVILLE TOD


LAND USE REVIEW PROJECT NUMBER **220120**

DATE 08/18/23

30 X 42
DRAWING TITLE LEVEL 2 LANDSCAPE PLANS

SHEET NUMBER

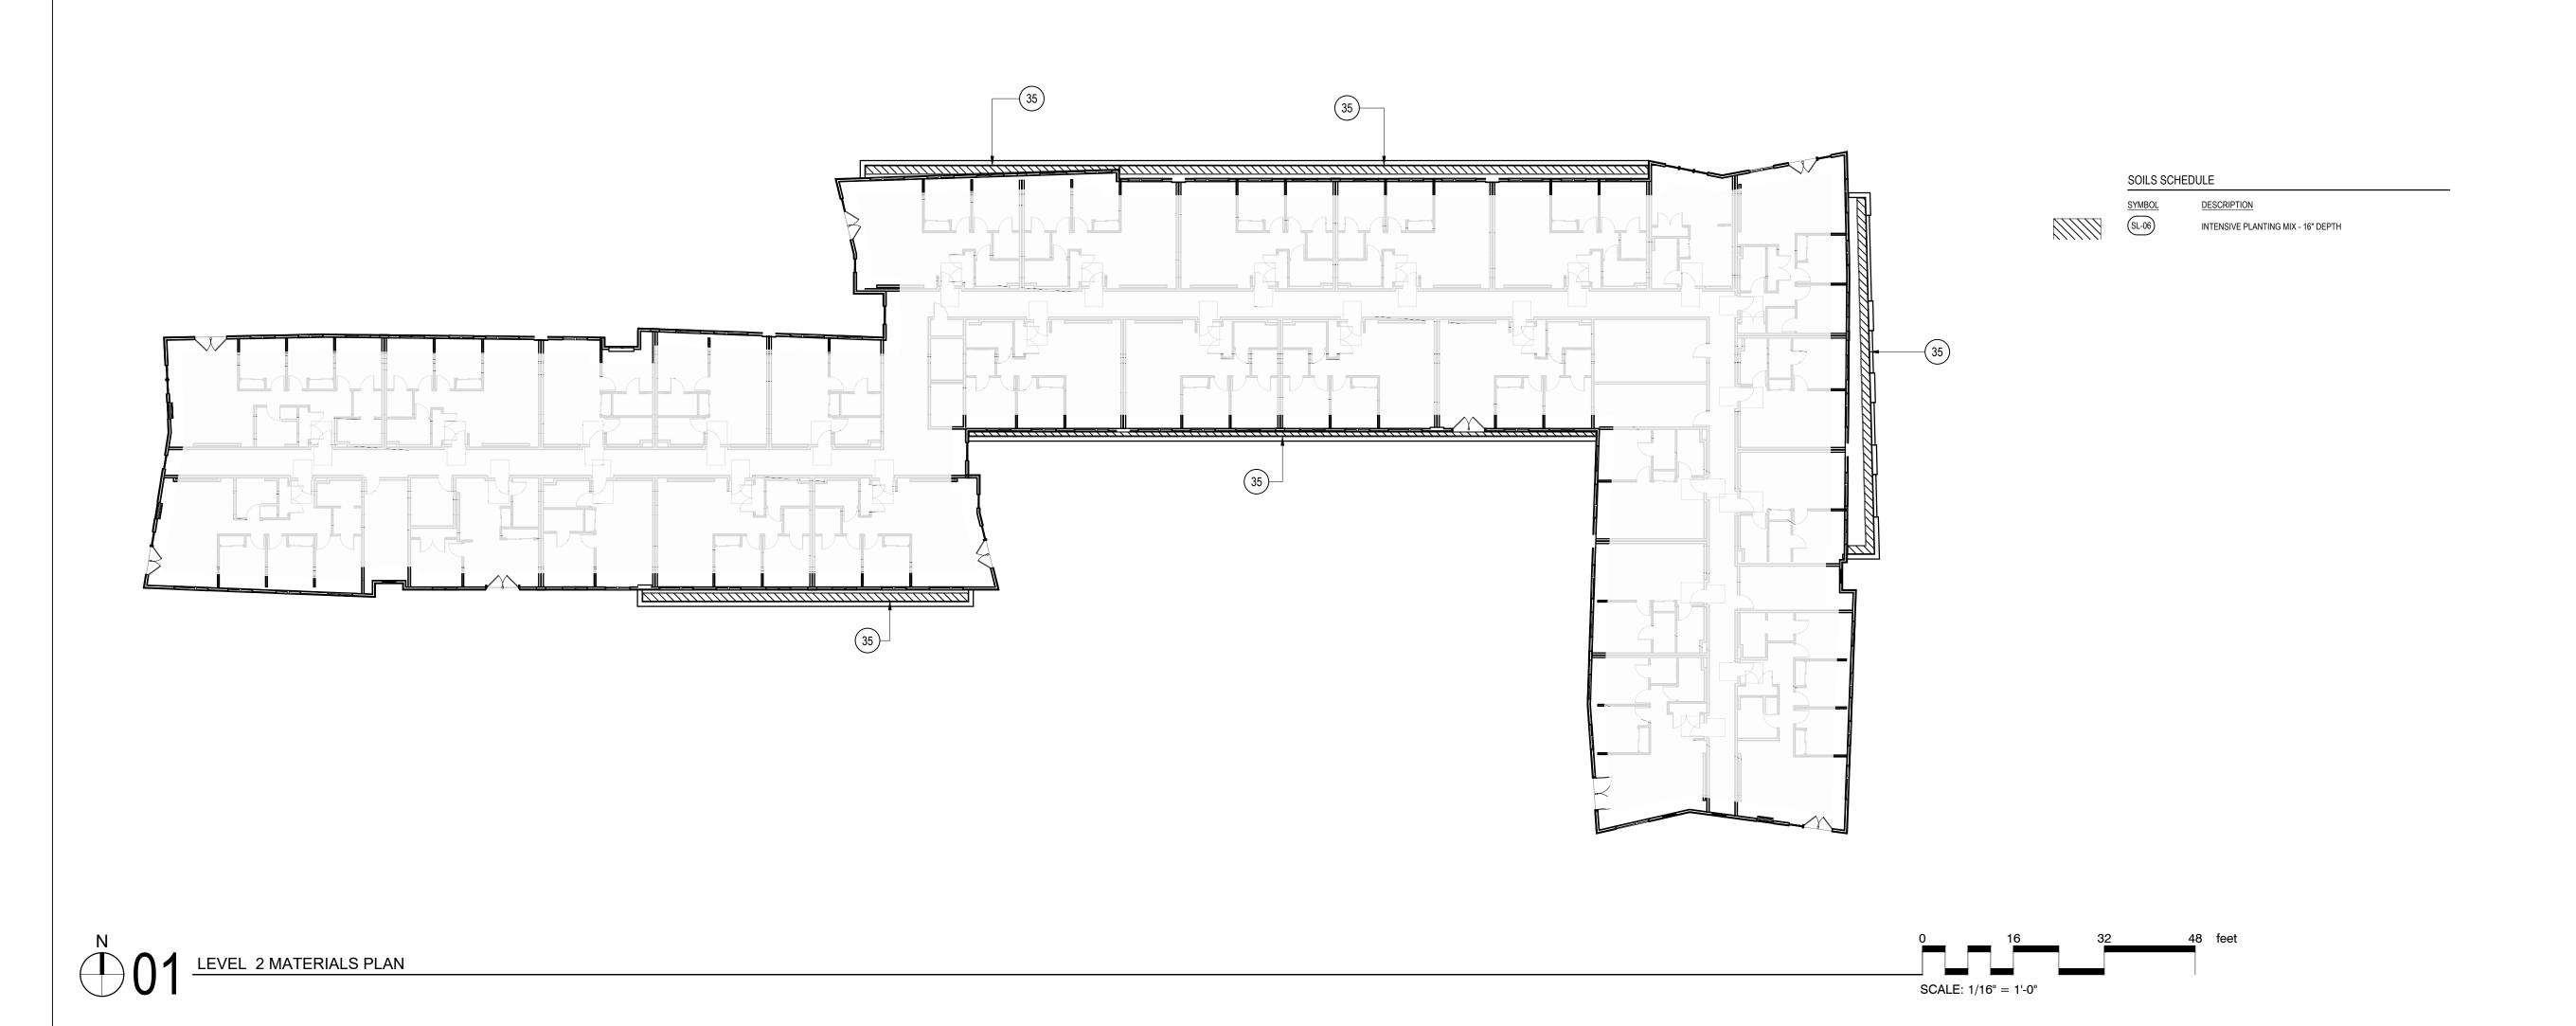


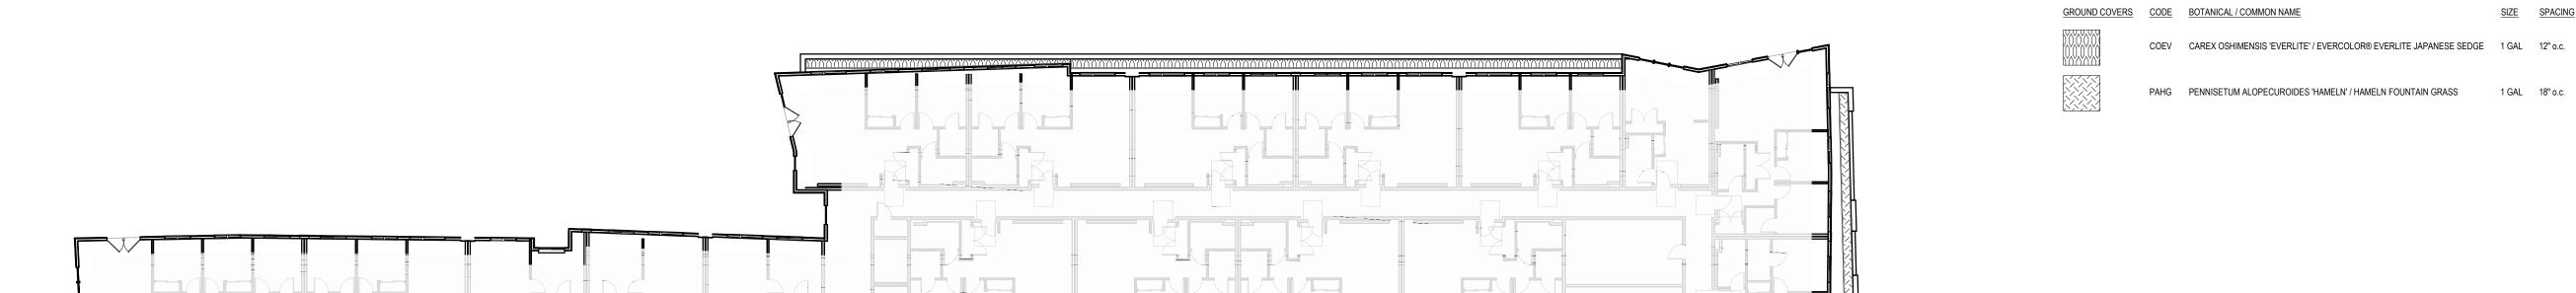

LEVEL 2 PLANTING PLAN

PLANT SCHEDULE

SIZE SPACING

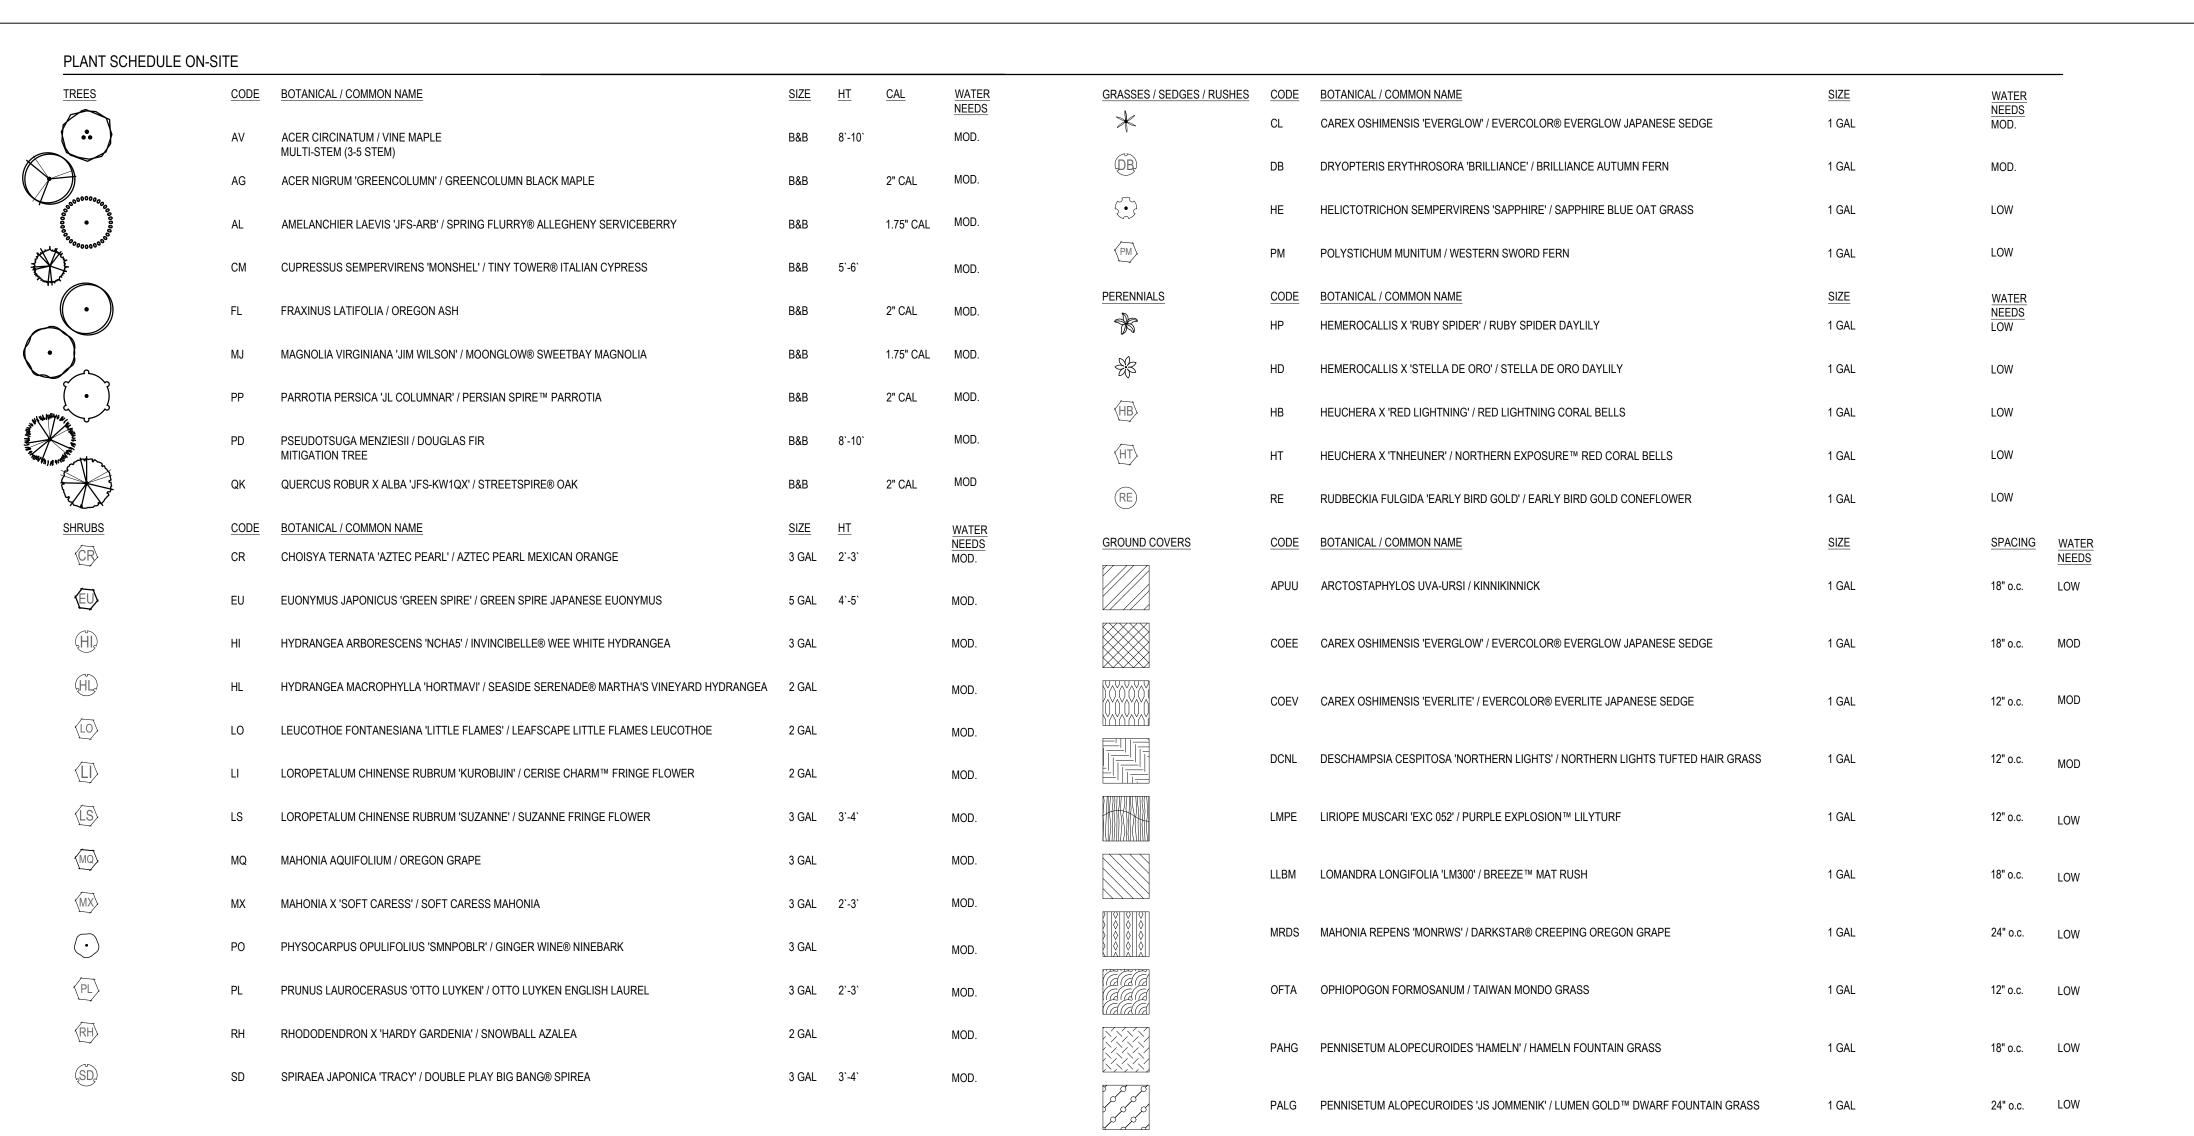

STORMWATER FACILITY PLANTING TYPES I

				-
0000	HERBACEOUS PLANTS - 115 PLANTS PER 100SF CAREX DENSA / DENSE SEDGE CAREX RUPESTRIS / CURLY SEDGE CAREX TESTACEA 'PRAIRIE FIRE' / PRAIRIE FIRE ORANGE SEDGE JUNCUS PATENS 'ELK BLUE' / SPREADING RUSH	SIZE HEIGHT 1 GAL 1 GAL 1 GAL 1 GAL	SPACING 1' oc 1' oc 1' oc 1' oc	WATER NEEDS LOW LOW LOW LOW
	SHRUBS / GROUNDCOVER - 4 PER 100SF CORNUS SERICEA 'KELSEYI' / KELSEY'S DWARF RED TWIG DOGWOOD MAHONIA AQUIFOLIUM / OREGON GRAPE PHYSOCARPUS CAPITATUS / PACIFIC NINEBARK POLYSTICHUM MUNITUM / WESTERN SWORD FERN	1 GAL 1 GAL 1 GAL 1 GAL	2' oc 3' oc 3' oc 2' oc	LOW LOW LOW
	LARGE SHRUBS / SMALL TREES - 3 PER 100SF SALIX PURPUREA 'NANA' / DWARF PURPLE OSIER WILLOW SPIRAEA DOUGLASII / WESTERN SPIREA VIBURNUM EDULE / HIGHBUSH CRANBERRY	3 GAL, 2`-6" 1 GAL, 2`-6" 1 GAL, 2`-6"	6' oc 4' oc 4' oc	LOW LOW LOW

STORMWATER FACILITY PLANTINGS TYPE II TREE SCHEDULE


	TREES	CODE	BOTANICAL / COMMON NAME	SIZE	<u>HT</u>	CAL	WATE NEED:
, <u> </u>		AC	ACER CIRCINATUM / VINE MAPLE STORMWATER TREE / MULTI STEM (3 STEM MIN.)	B&B	5`-6`		MOD.
Q		AB	ACER RUBRUM 'BOWHALL' / BOWHALL RED MAPLE STORMWATER / PARKING TREE	B&B		1.75" CAL	MOD.
	$\left(\cdot \right)$	AF	ACER RUBRUM 'FRANKSRED' / RED SUNSET® MAPLE STORMWATER TREE	B&B		2" CAL	MOD.

PLANT SCHEDULE ROW

PLANT SCHEDU	JLE ROV	V				
TREES	CODE	BOTANICAL / COMMON NAME	SIZE	CAL		WATER NEEDS
	AG	ACER NIGRUM 'GREENCOLUMN' / GREENCOLUMN BLACK MAPLE	B&B	2" CAL		MOD.
GROUND COVERS	CODE	BOTANICAL / COMMON NAME	SIZE		SPACING	WATER NEEDS
	APUU	ARCTOSTAPHYLOS UVA-URSI / KINNIKINNICK	1 GAL		18" o.c.	LOW
	LLBM	LOMANDRA LONGIFOLIA 'LM300' / BREEZE™ MAT RUSH	1 GAL		18" o.c.	LOW
	PAHG	PENNISETUM ALOPECUROIDES 'HAMELN' / HAMELN FOUNTAIN GRASS	1 GAL		18" o.c.	LOW



T: 971.888.5107 - E-MAIL: INFO@YB-A.COM

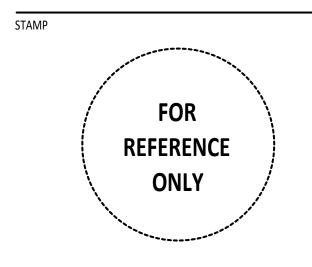

SHEET REVISION REVISION NO. EVENT

IT

TRUE PLAN NORTH

WILSONVILLE TOD

PALINDROME COMMUNITIES

ISSUANCE
LAND USE REVIEW

PROJECT NUMBER
220120


DATE
08/18/23

FULL SHEET SIZE
30 X 42

LEVEL 1 PLANTING PLAN

SHEET NUMBER

L4

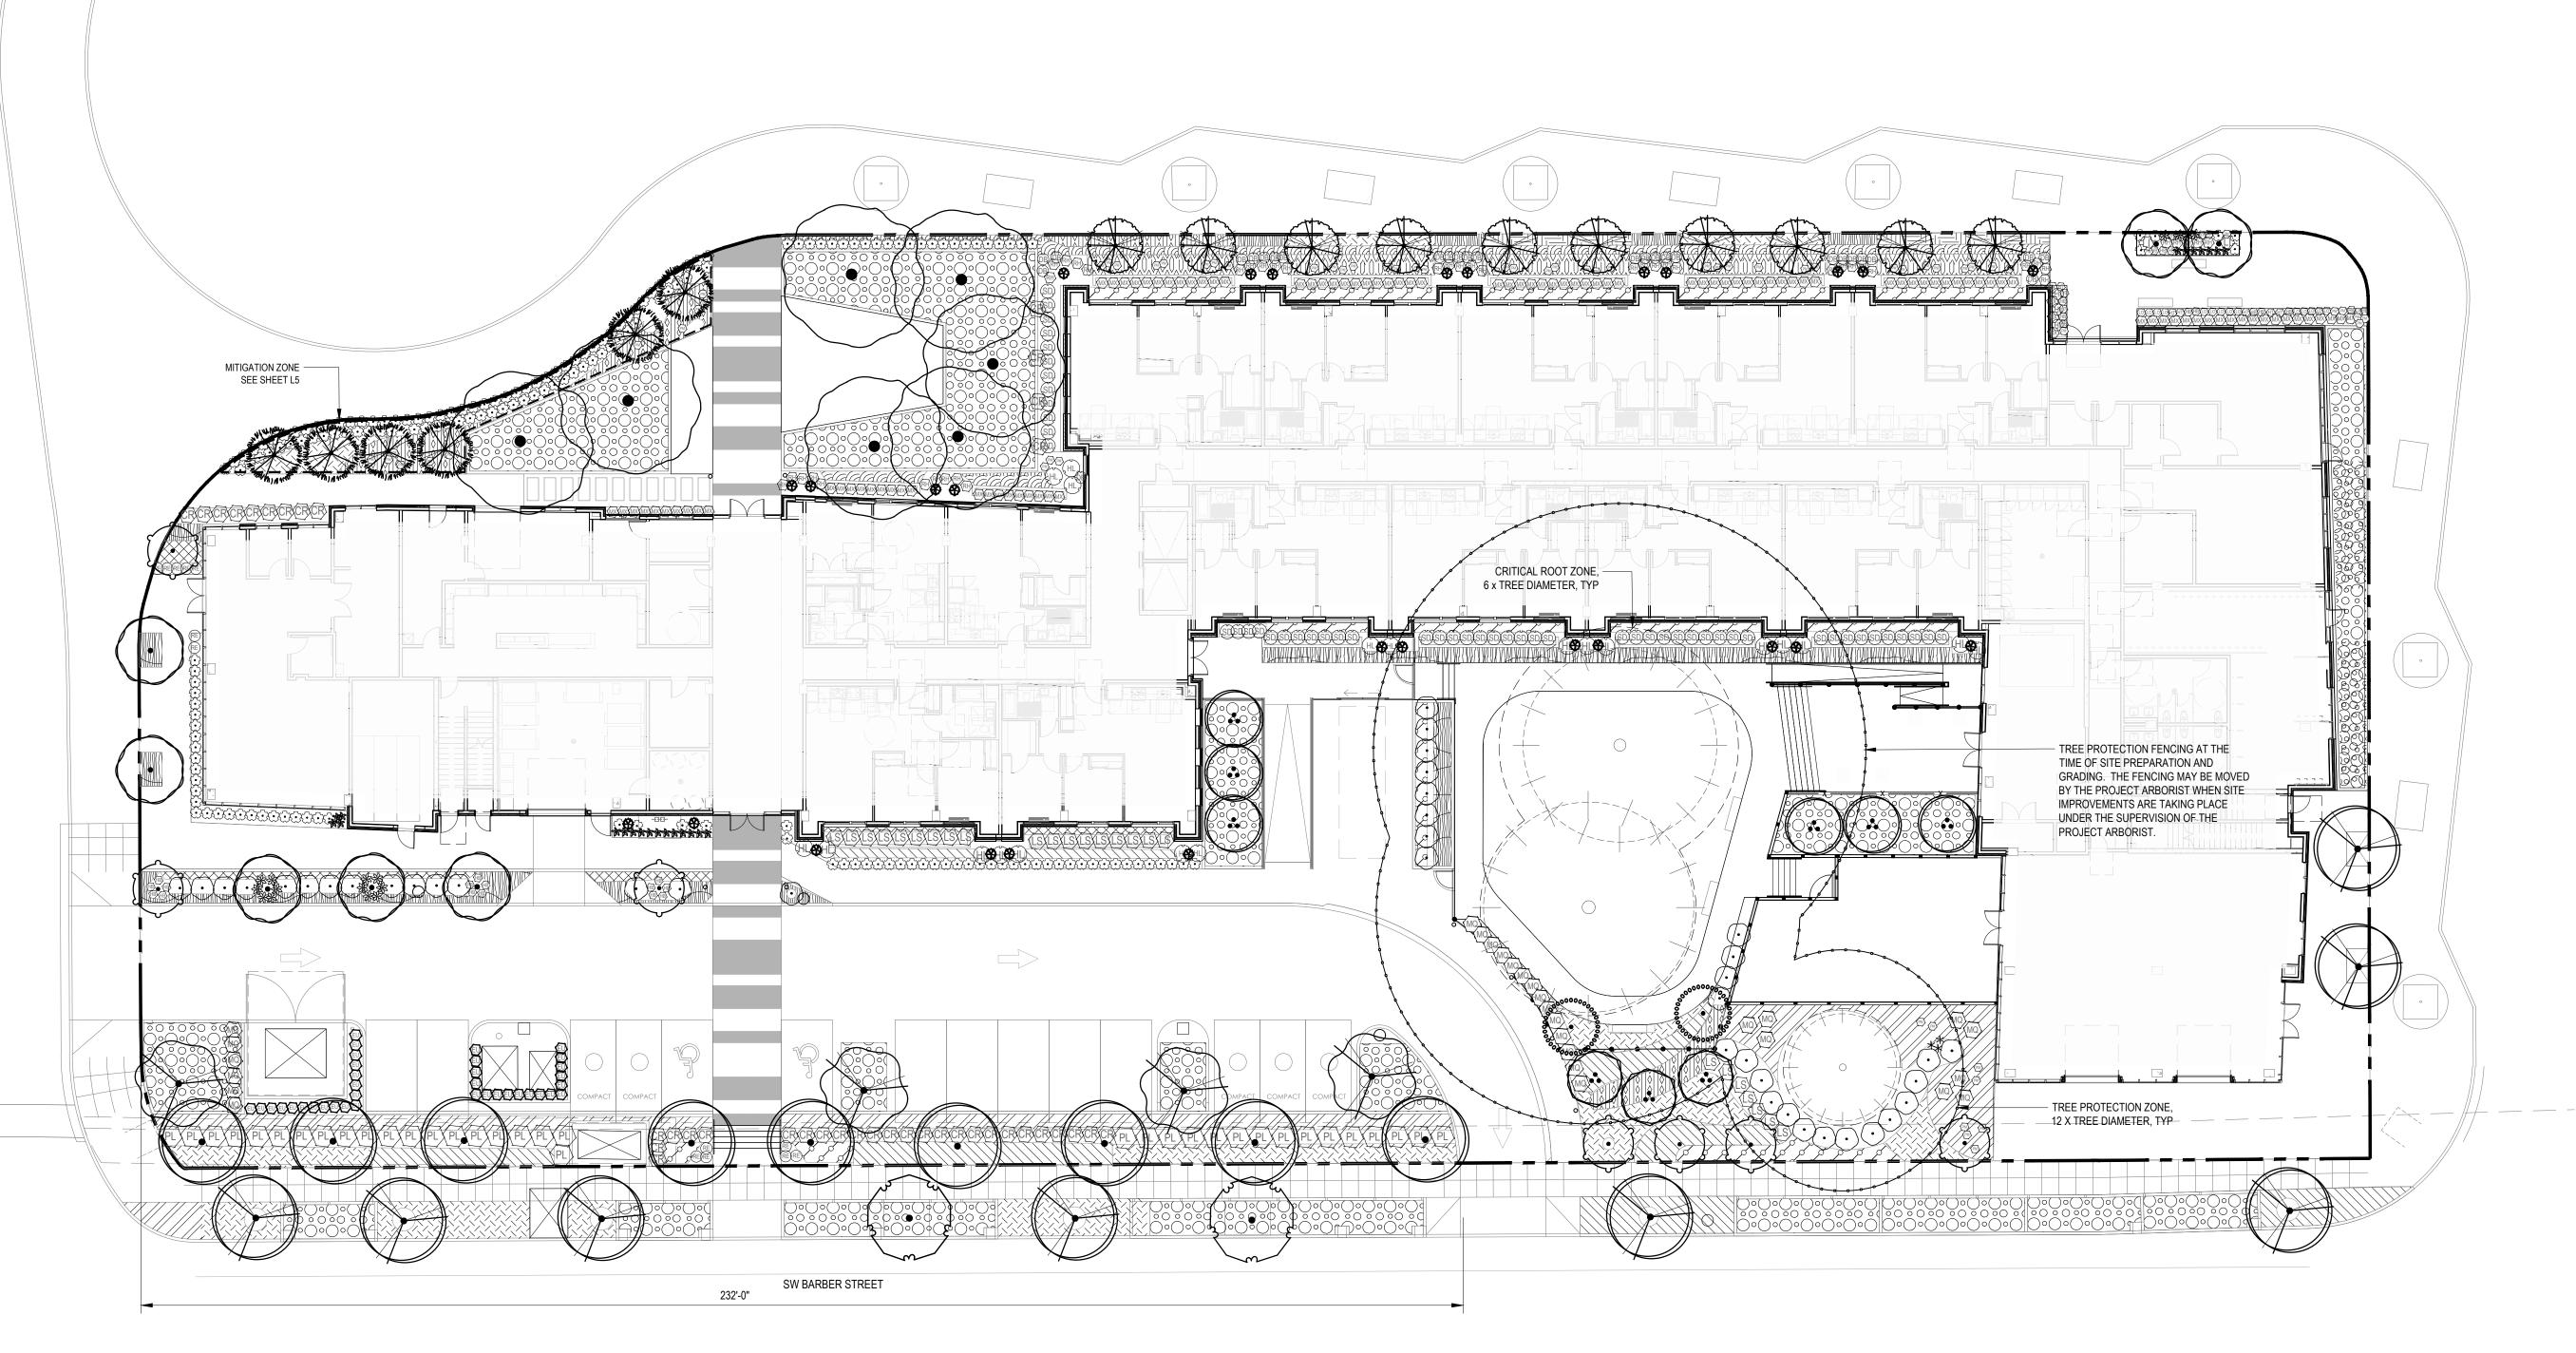

LEVEL 1 PLANTING PLAN




MITIGATION NOTES

- A. PLANT MATERIALS ARE TO BE NATIVE AND ARE SUBJECT TO APPROVAL BY THE CITY OF WILSONVILLE, OREGON. PLANTS MUST BE AS LOCAL AS POSSIBLE, NURSERY PROPAGATED OR TAKEN FROM A PRE-APPROVED TRANSPLANTATION AREA. PLANT MATERIALS SHALL BE OF THE TYPE AND SIZE INDICATED ON THE MITIGATION PLAN DRAWINGS.
- B. PESTICIDES, FUNGICIDES AND FERTILIZERS SHALL NOT BE EMPLOYED IN MITIGATION AREAS UNLESS SPECIFICALLY AUTHORIZED AND APPROVED.

 C. NATIVE PLANTS SHALL BE PLANTED IN SUITABLE SOIL CONDITIONS. TREES SHALL BE SUPPORTED ONLY WHEN NECESSARY BECAUSE OF EXTREME WINDS AT THE SITE. WHERE SUPPORT IS NECESSARY, ALL STAKES, GUY WIRES AND OTHER MEASURES ARE TO BE REMOVED.
- AS SOON AS THE PLANTS CAN SUPPORT THEMSELVES. PROTECT FROM ANIMAL AND FOWL PREDATION AND FORAGING UNTIL ESTABLISHMENT.
- D. TEMPORARY IRRIGATION SHALL BE PROVIDED WITHIN THE MITIGATION ZONE BY A DEDICATED DRIP ZONE. TEMPORARY IRRIGATION SHALL BE PROVIDED WITHIN MITIGATION ZONE FOR A MINIMUM OF ONE COMPLETE GROWING SEASON, OR UNTIL TREES BECOME ESTABLISHED, WHICH EVER IS THE LONGEST. ONCE TREES ARE ESTABLISHED, ZONE SHALL BE TURNED OFF, BUT SHALL REMAIN IN
- PLACE FOR POSSIBLE USE IN TIMES OF EXTREME DROUGHT IN THE FUTURE. E. MONITORING OF NATIVE LANDSCAPE AREAS IS THE ON-GOING RESPONSIBILITY OF THE PROPERTY OWNER. PLANTS THAT DIE ARE TO BE REPLACED IN KIND AND QUANTITY WITHIN ONE YEAR. WRITTEN PROOF OF THE SURVIVAL OF ALL PLANTS SHALL BE REQUIRED TO BE SUBMITTED TO THE CITY'S PLANNING DEPARTMENT ONE YEAR AFTER THE PLANTING IS COMPLETED.


50	SHAPIRO DIDWAY
1204 SE Water Ave	
Portland, Oregon 977	214
+1 503 232 0520	

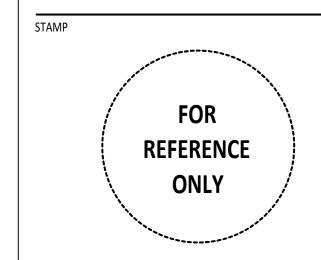

SHEET REVISION REVISION NO. EVENT



CITY OF WILSONVILLE, OREGON PLANNING	AND DEVELOPMENT CODE LANDSCAPED ARE	EAS
MITIGATION PLAN		
1 NEW NATIVE TREE FOR EACH NATIVE TREE REMOVED	EXISTING NATIVE TREES REMOVED	NEW NATIVE TREES PROVIDED
	6	6

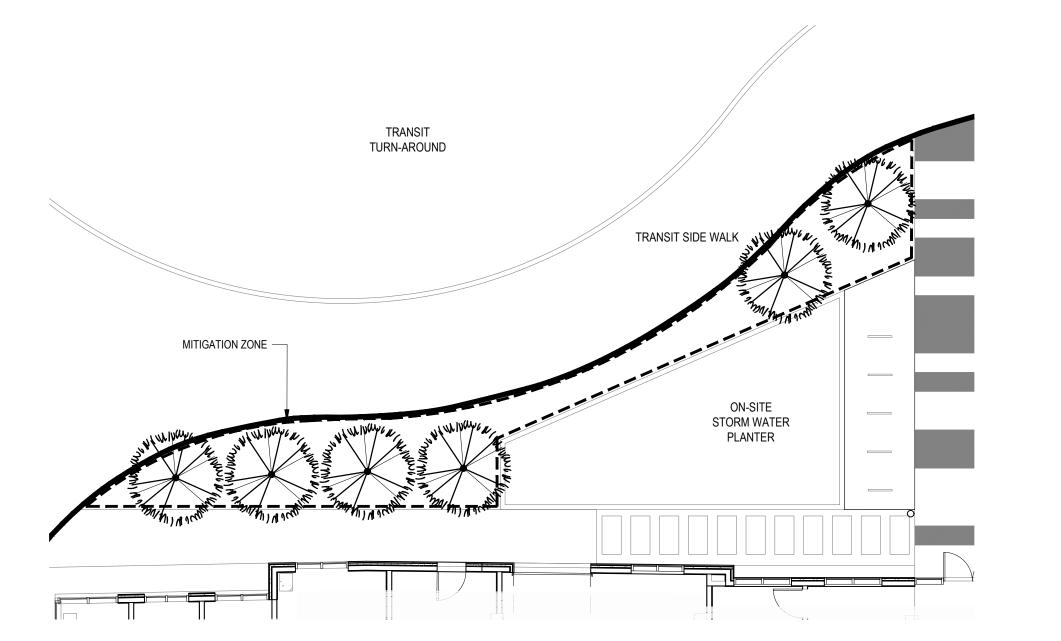

MITIGATION TREE SCHEDULE

CODE BOTANICAL / COMMON NAME



PD PSEUDOTSUGA MENZIESII / DOUGLAS FIR B&B 8`-10` 6



SHEET NUMBER

TRUE PLAN NORTH

PALINDROME COMMUNITIES

LAND USE REVIEW

PROJECT NUMBER **220120**


DATE 08/18/23


FULL SHEET SIZE

30 X 42
DRAWING TITLE

MITIGATION PLAN

WILSONVILLE TOD

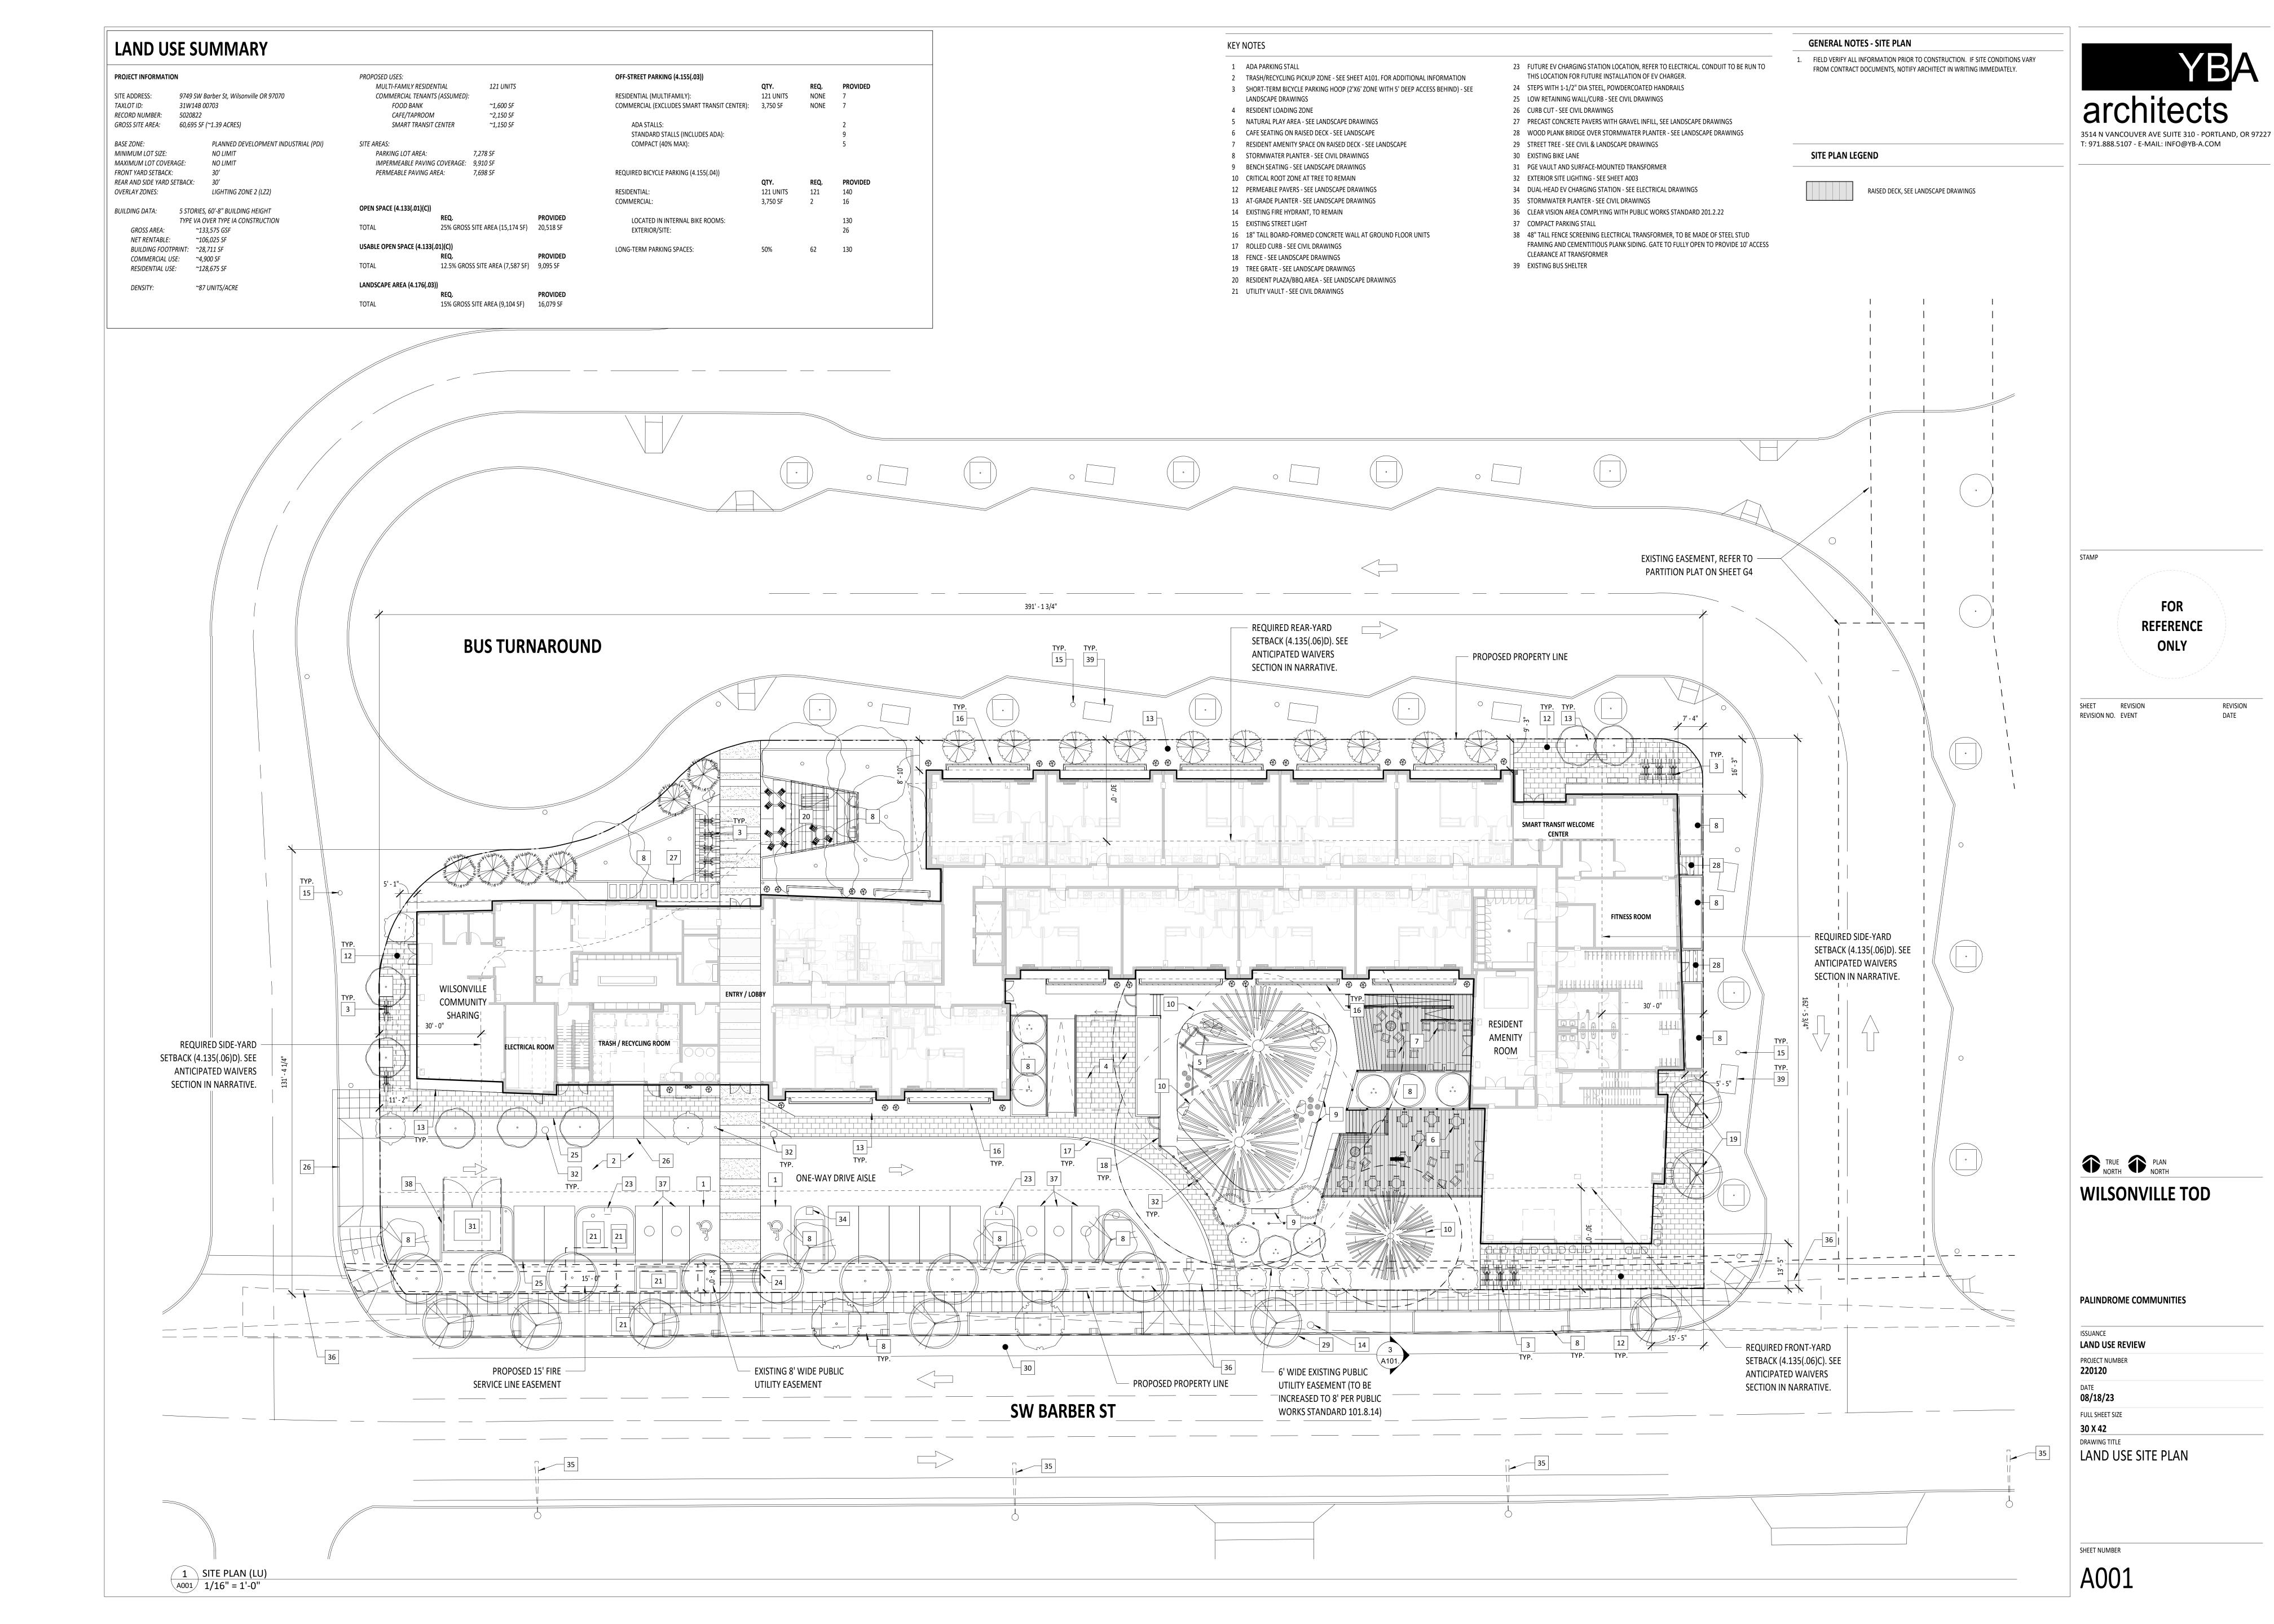

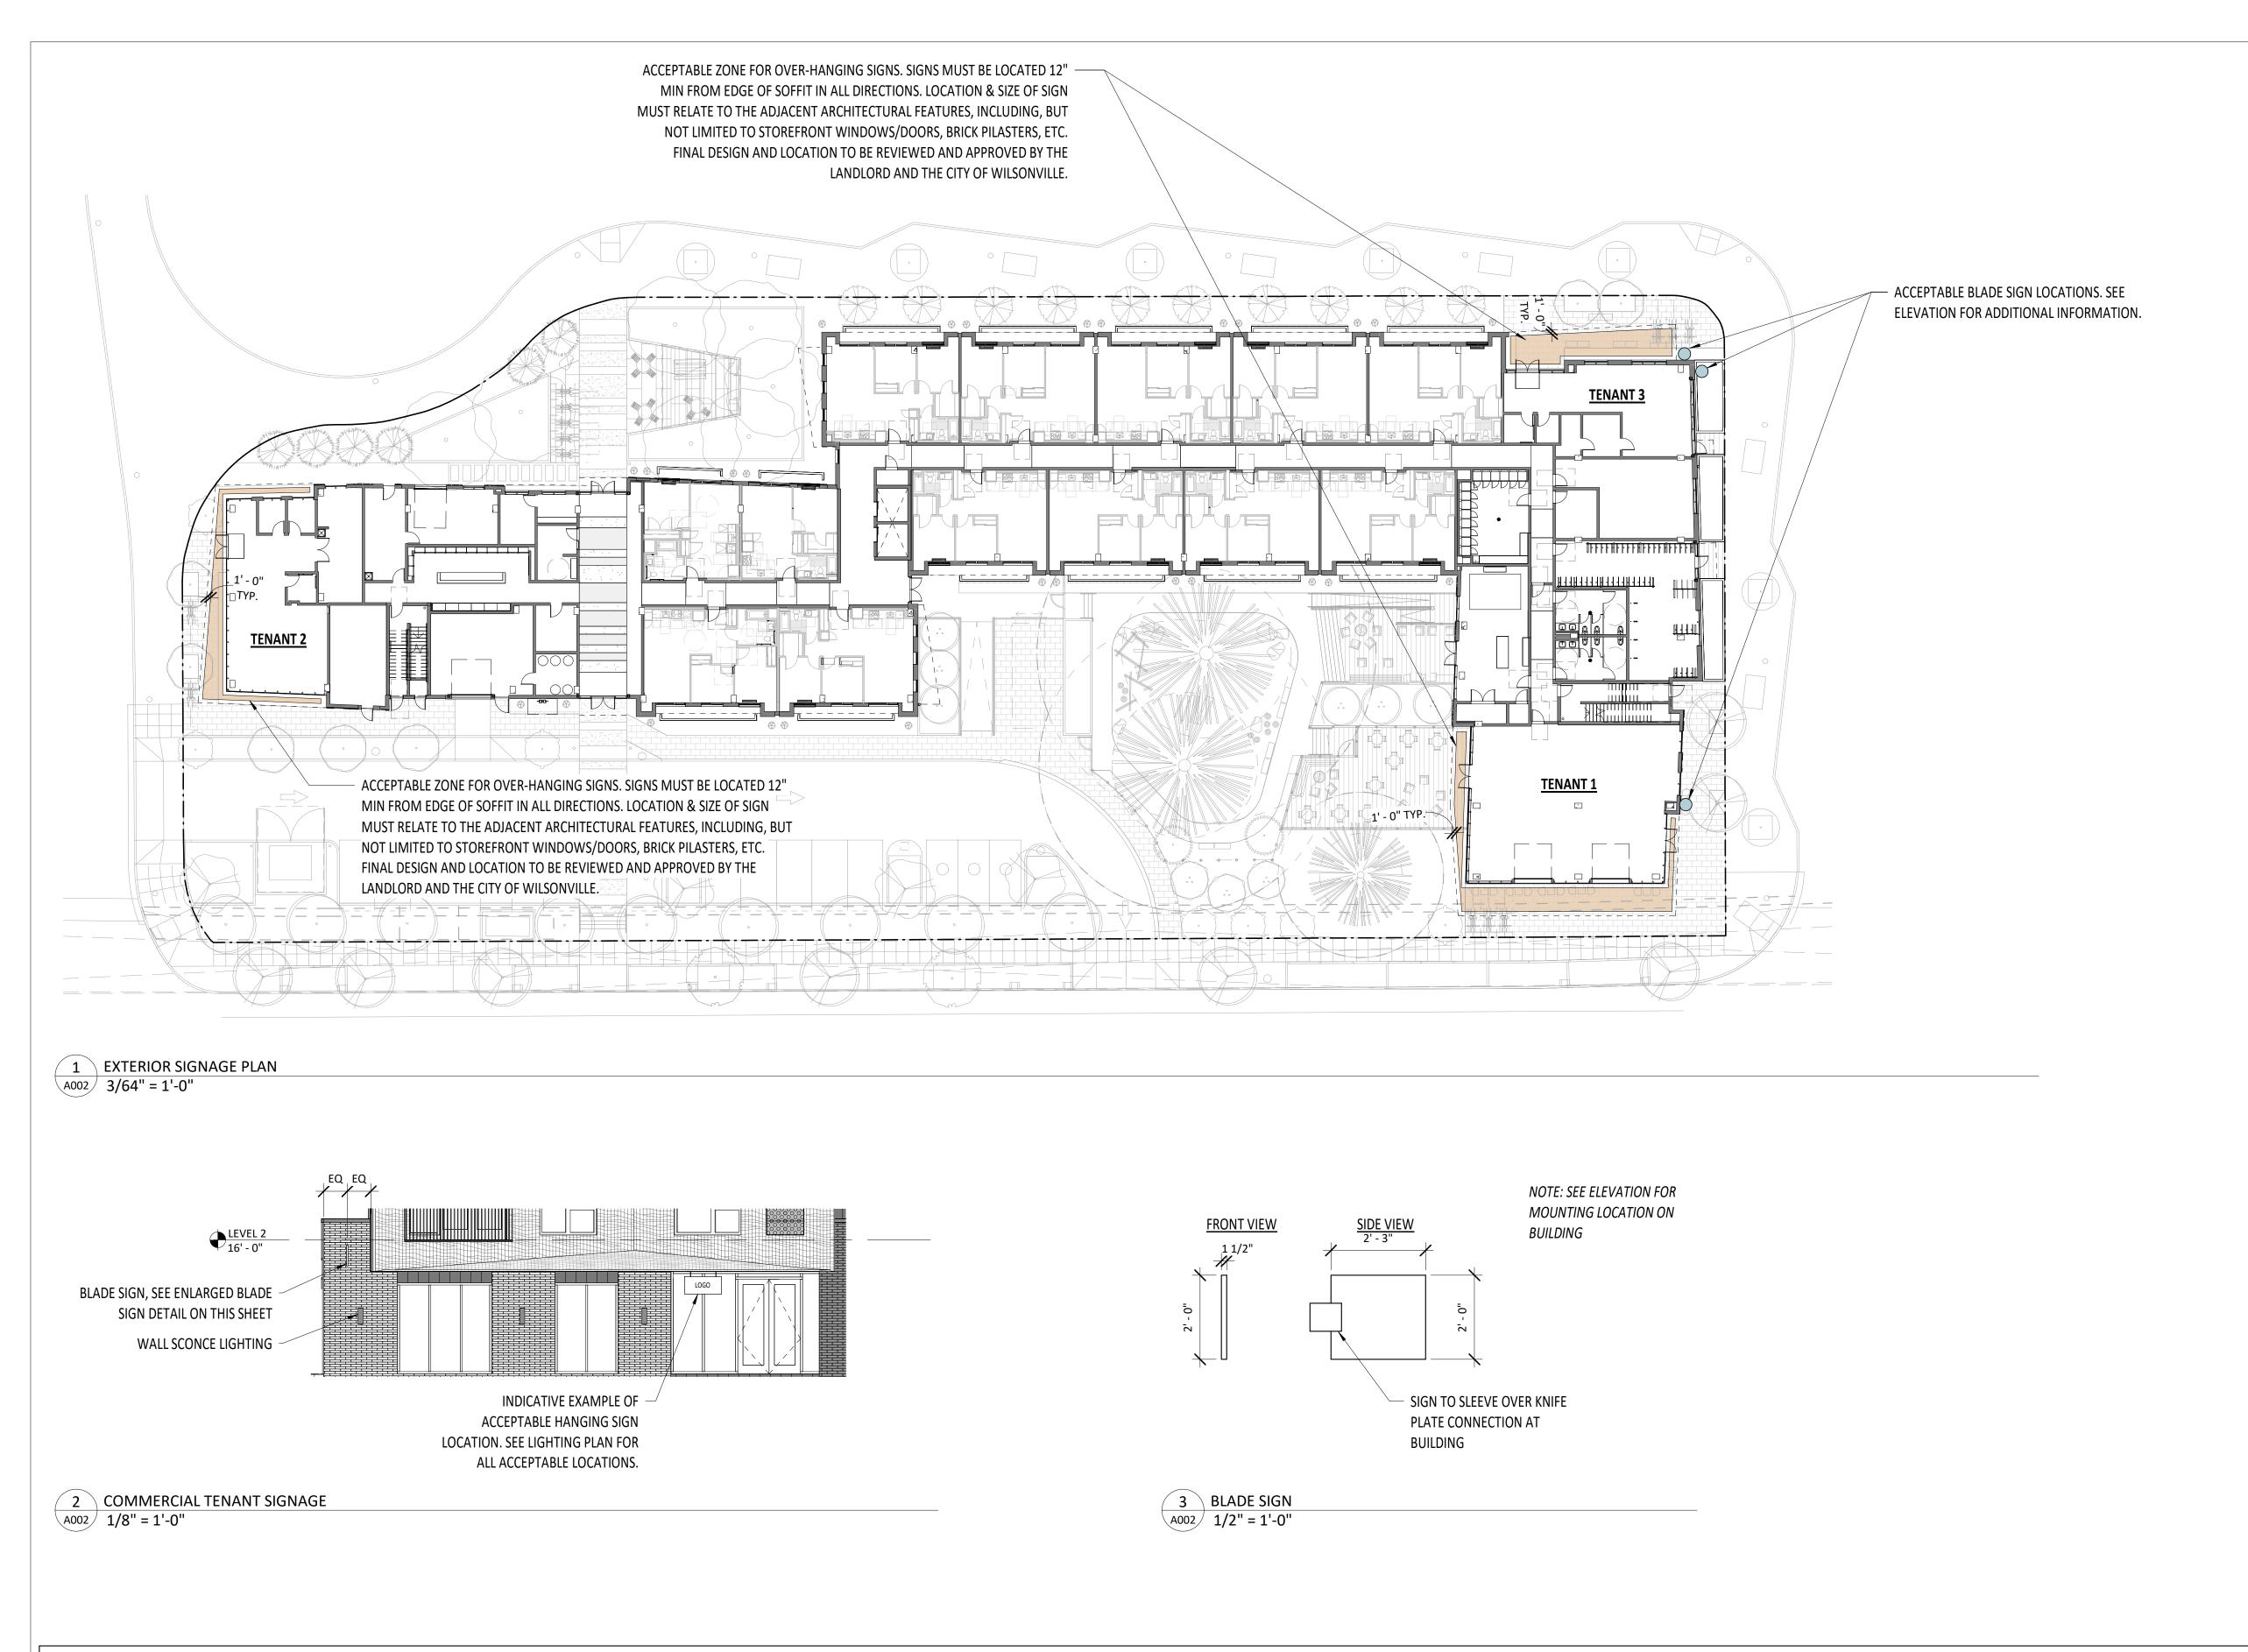

MASTER SIGN PLAN DOCUMENTATION

MASTER SIGN PLAN

To ensure design & visual integrity of the Wilsonville Transit-Oriented-Development project (WTOD), all procedural guidelines for Tenant signage work as specified will be required. All proposed design solutions must be reviewed and approved by the Landlord and the City of Wilsonville prior to fabrication. It will be the Tenant's responsibility to provide a copy of these guidelines to the Sign Contractor. The Tenant is responsible for applying for building and/or sign permits as required by the City of Wilsonville.

These guidelines have been established to assist future tenants in creating a retail design solution that highlights their product or service while also reinforcing the design excellence of the WTOD project as a whole. This criterion aims to support tenants throughout the design review process and establish baseline standards and objectives for the visual appearance of the buildings and site. All signage should fulfill both the communicative purposes of a sign and its aesthetic integration with the overall retail

The signage and logos of tenants located within the WTOD project should express a refined urban sophistication through the use of clean and contemporary shapes and forms. It is recommended to use the same building materials for the signage as the rest of the structure to create a seamless transition between the building and the tenant space. The design of tenant signage should be suitable and indicative of the tenant's business activities. The tenant sign designs should complement and enhance the building's overall character by using appropriate scale, color, materials, and lighting levels.

Signage zones are shown on the plans and elevations as indicated, and is the specific area in which Tenant signage must be installed. All signs are to meet the City of Wilsonville, Section 4.156.08 Sign Regulations in the PDC, TC, PDI, and PF Zones.

STOREFRONT SIGNAGE CRITERIA

EXTERIOR SIGNAGE

All signage designed for exterior identification of a retail space shall be designed for complete compatibility with building finishes, color scheme, and lighting levels, to maintain a design standard throughout the building. All primary signage will be limited to trade names and logos.

FORMAT, FABRICATION, COLOR & LIGHTING OF SIGNAGE

The design format, construction techniques, and intricacies of a retail sign program facilitate it's seamless integration into the building, while also enabling the Tenant's branding identity to be distinctly visible. Adhering to the aforementioned standards, as well as those listed below, will ensure that the Tenant establishes a vital connection between their design statement and signage program.

Pre-approved location, hanging signs, and blade signs. These locations follow the specific height and placement limitations as outlined in the plan & elevations.

Wilsonville TOD Master Sign Plan

ACCEPTABLE FORMAT AND PROPORTIONS FOR SIGNS

Building standard letter height and sign format area are determined by signage guidelines based on the architectural design and City sign codes. General limitations are outlined in the images below.



Non-illuminated blade sign Illuminated blade sign



Overhanging blade sign Illuminated overhanging blade sign

ACCEPTABLE FABRICATION METHODS AND MATERIALS FOR SIGNAGE Signs shall be constructed of high-quality, durable materials. All materials used should relate to the

- architectural character and material of the building. ACCEPTABLE COLORS Any colors that are integral to the Tenant logo, or word mark, and are limited to use within the
- graphic sign field. Colors that are indigenous to the sign material, as in finished metals. All sign structure colors/finishes should be complementary to the building. Wilsonville TOD Master Sign Plan

• Paint finish and architectural metals that connect to the building architecture should reflect the

- Color Material finishes will be reviewed and approved by the Landlord. ACCEPTABLE LIGHTING
- Custom armature with integrated light fixtures.
- Internally illuminated sign cabinets that illuminate the logo or word mark and not the overall
- All signs shall use energy-efficient lighting; LED. Blade Signs can be non-illuminated or illuminated.

materials/color palette of the building.

UNACCEPTABLE LOCATIONS

Any signage applied directly to the building that does not comply with the outlined standard of this Master Sign Plan.

UNACCEPTABLE FORMAT, LETTER, AND HEIGHTS FOR SIGNS

Refer to sample images below. In addition, no freestanding or ground mounted signs will be allowed. Aframe signage is not covered in these guidelines.









Wilsonville TOD Master Sign Plan





page 4

UNACCEPTABLE FABRICATION METHODS AND MATERIALS

 Unpainted steel or other unfinished metals, aside from stainless steel. Vacuum formed plastic letters, logos, and word marks.

Portable Signs

- Any fabrication with exposed fasteners, unless architecturally integral to the sign and relates to the architectural design of the building. Sign must be reviewed and approved by the Landlord.
- There should be limited visibility of exposed conduits, tubing and raceways. Transformers or related equipment shall be concealed whenever possible, and not visible to the public.

UNACCEPTABLE COLORS

Day-Glo or reflective paints.

Signs with flashing or strobing lights, or lighting that changes color.

Wilsonville TOD Master Sign Plan




GENERAL NOTES - SIGNAGE PLAN

APPROVED GUIDELINES.

2. REFER TO MASTER SIGN PLAN DOCUMENTATION ON

3. FUTURE TENANT SIGNAGE LOCATIONS INDICATED ON

DRAWINGS 1/A002 & 2/A002. EACH TENANT WILL BE LIMITED TO TWO SIGNS - EITHER TWO OVER-HANGING SIGNS OR ONE OVER-HANGING SIGN AND ONE BLADE

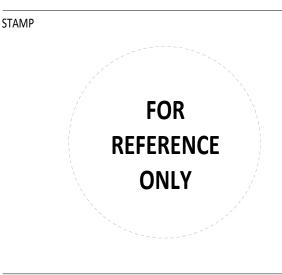

REVISION

DATE

REVISION

SHEET

REVISION NO. EVENT




PALINDROME COMMUNITIES


EXTERIOR SIGNAGE PLAN

SHEET NUMBER

DRAWING TITLE

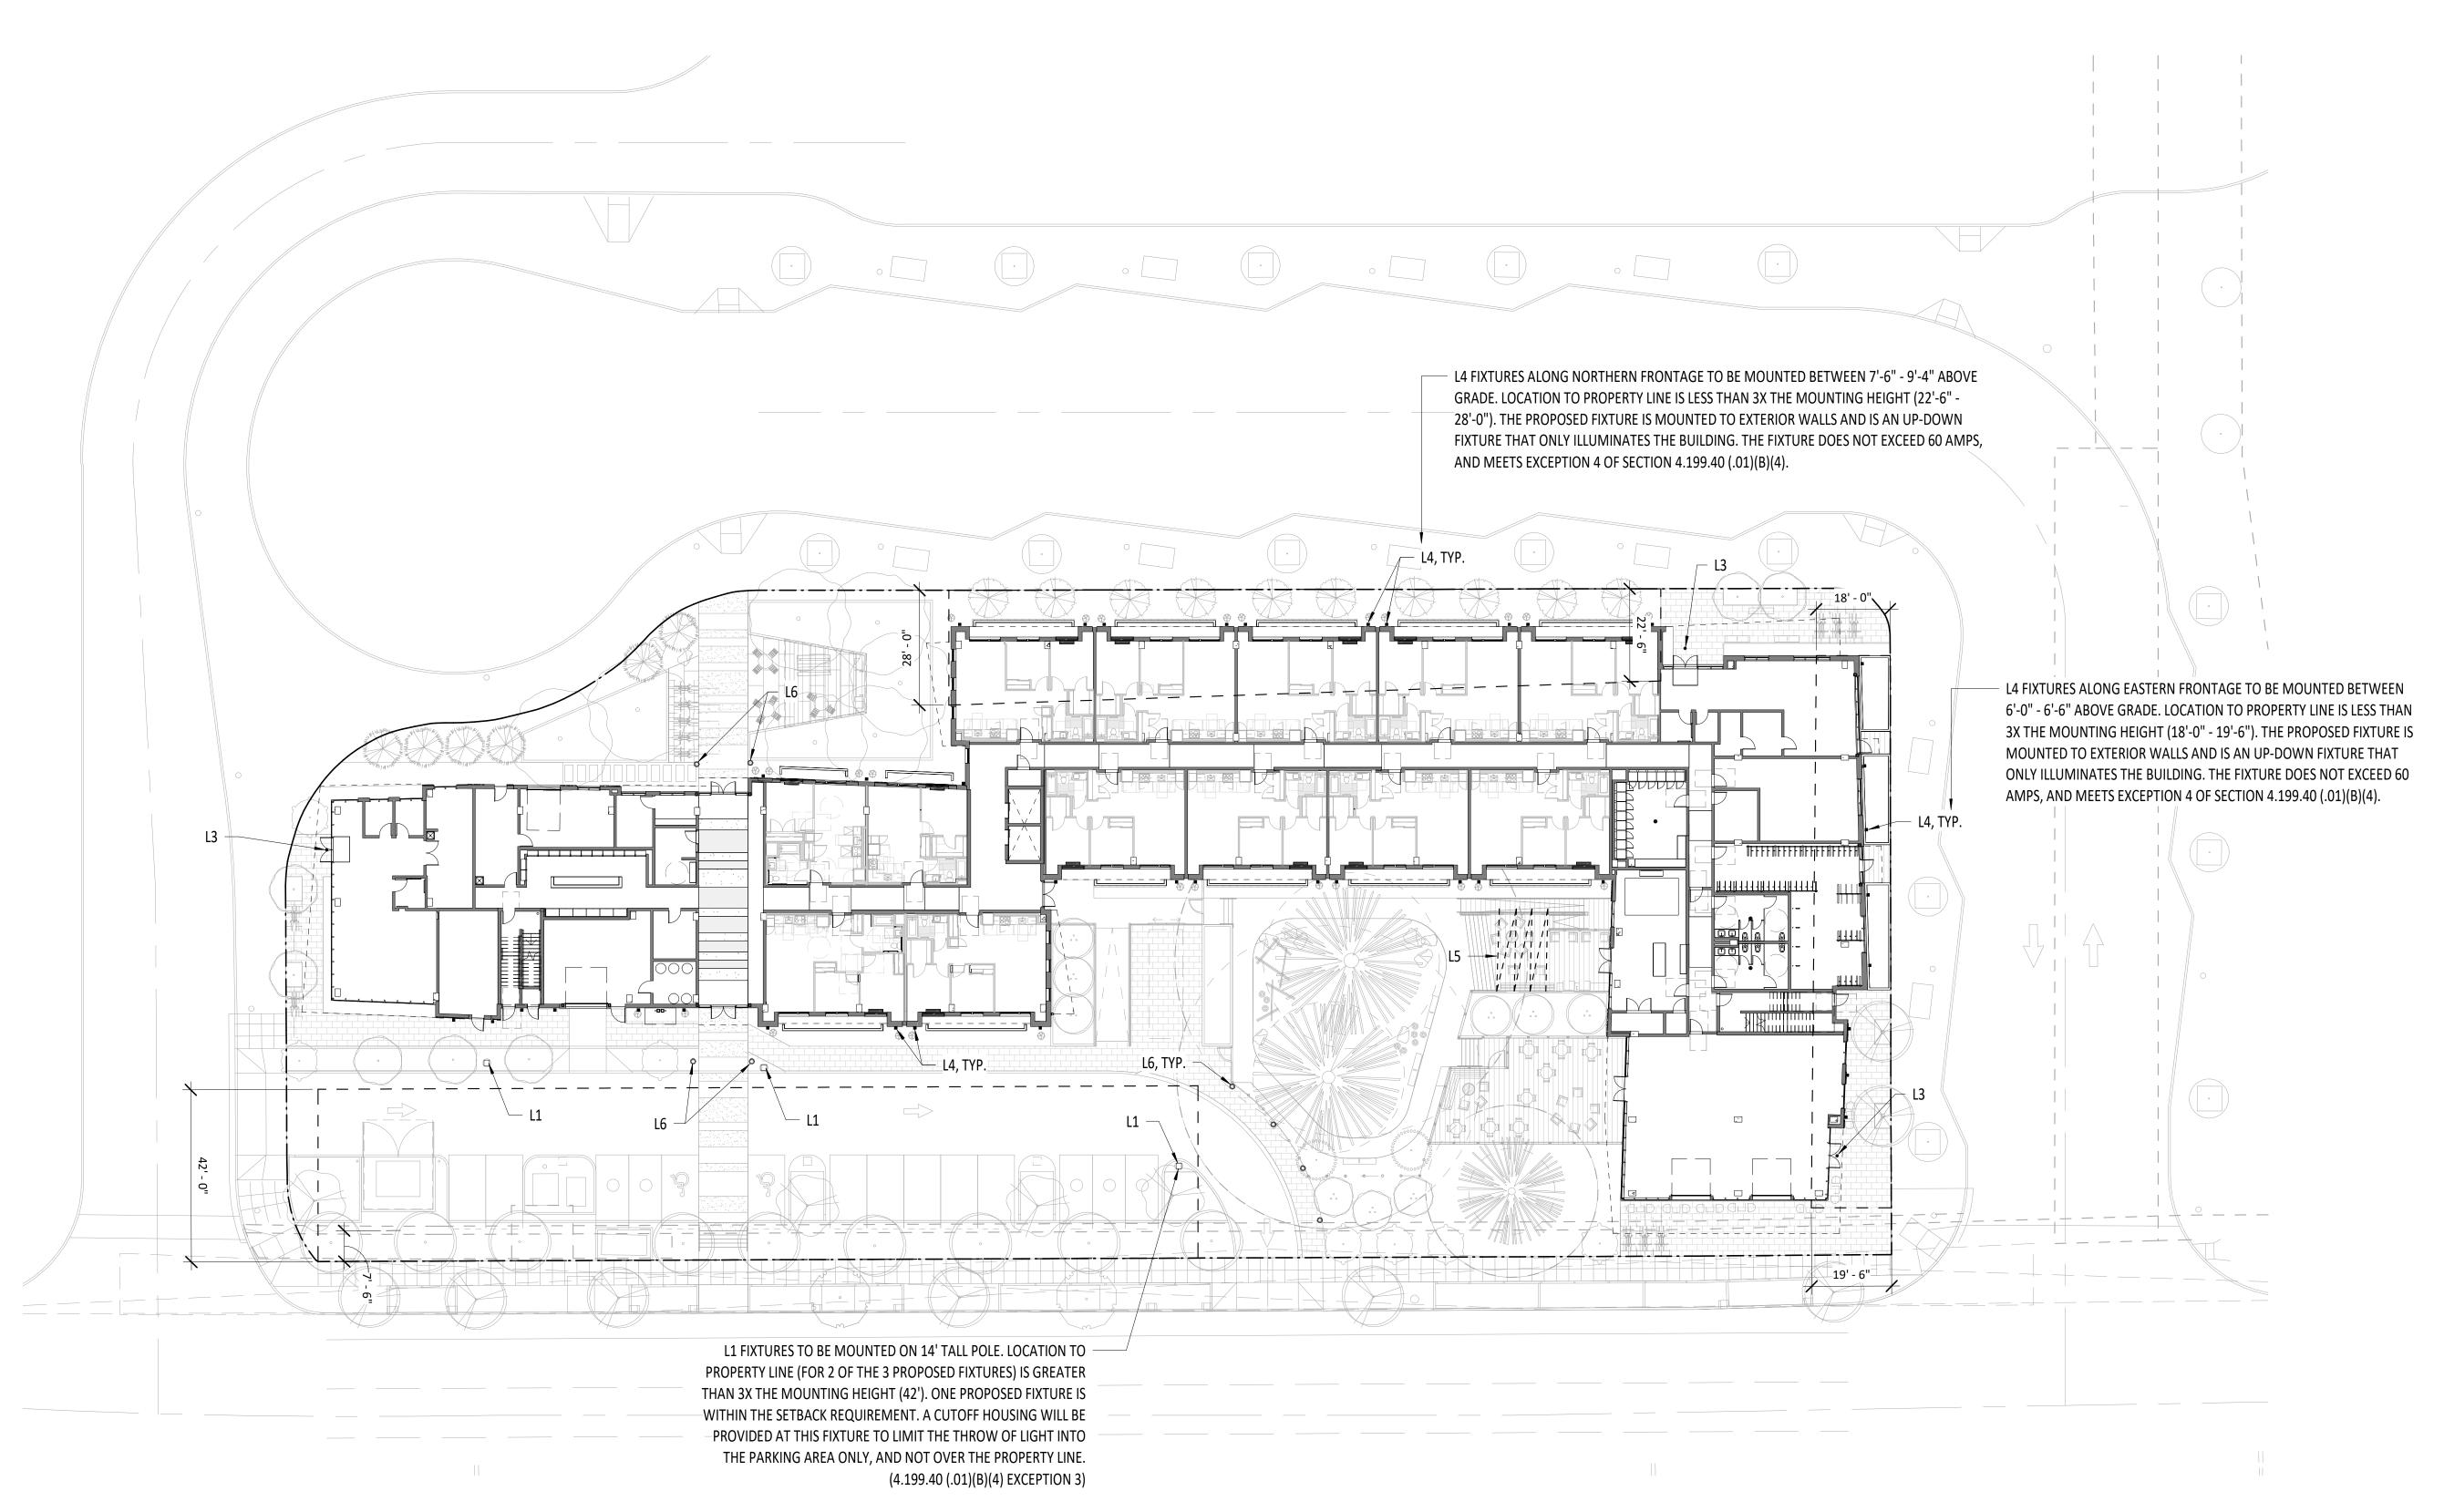



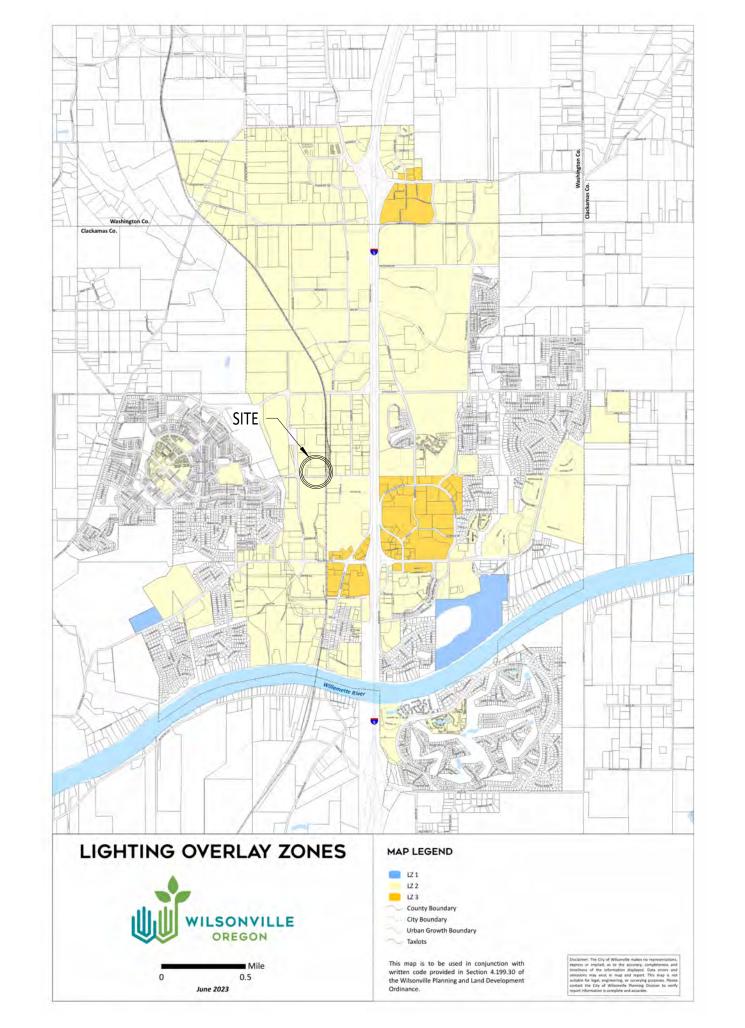



REFERENCE ONLY SHEET REVISION REVISION NO. EVENT


TRUE PLAN NORTH **WILSONVILLE TOD**

PALINDROME COMMUNITIES

LAND USE REVIEW PROJECT NUMBER 30 X 42 EXTERIOR LIGHTING PLAN

A003

1 EXTERIOR LIGHTING PLAN A003 3/64" = 1'-0"

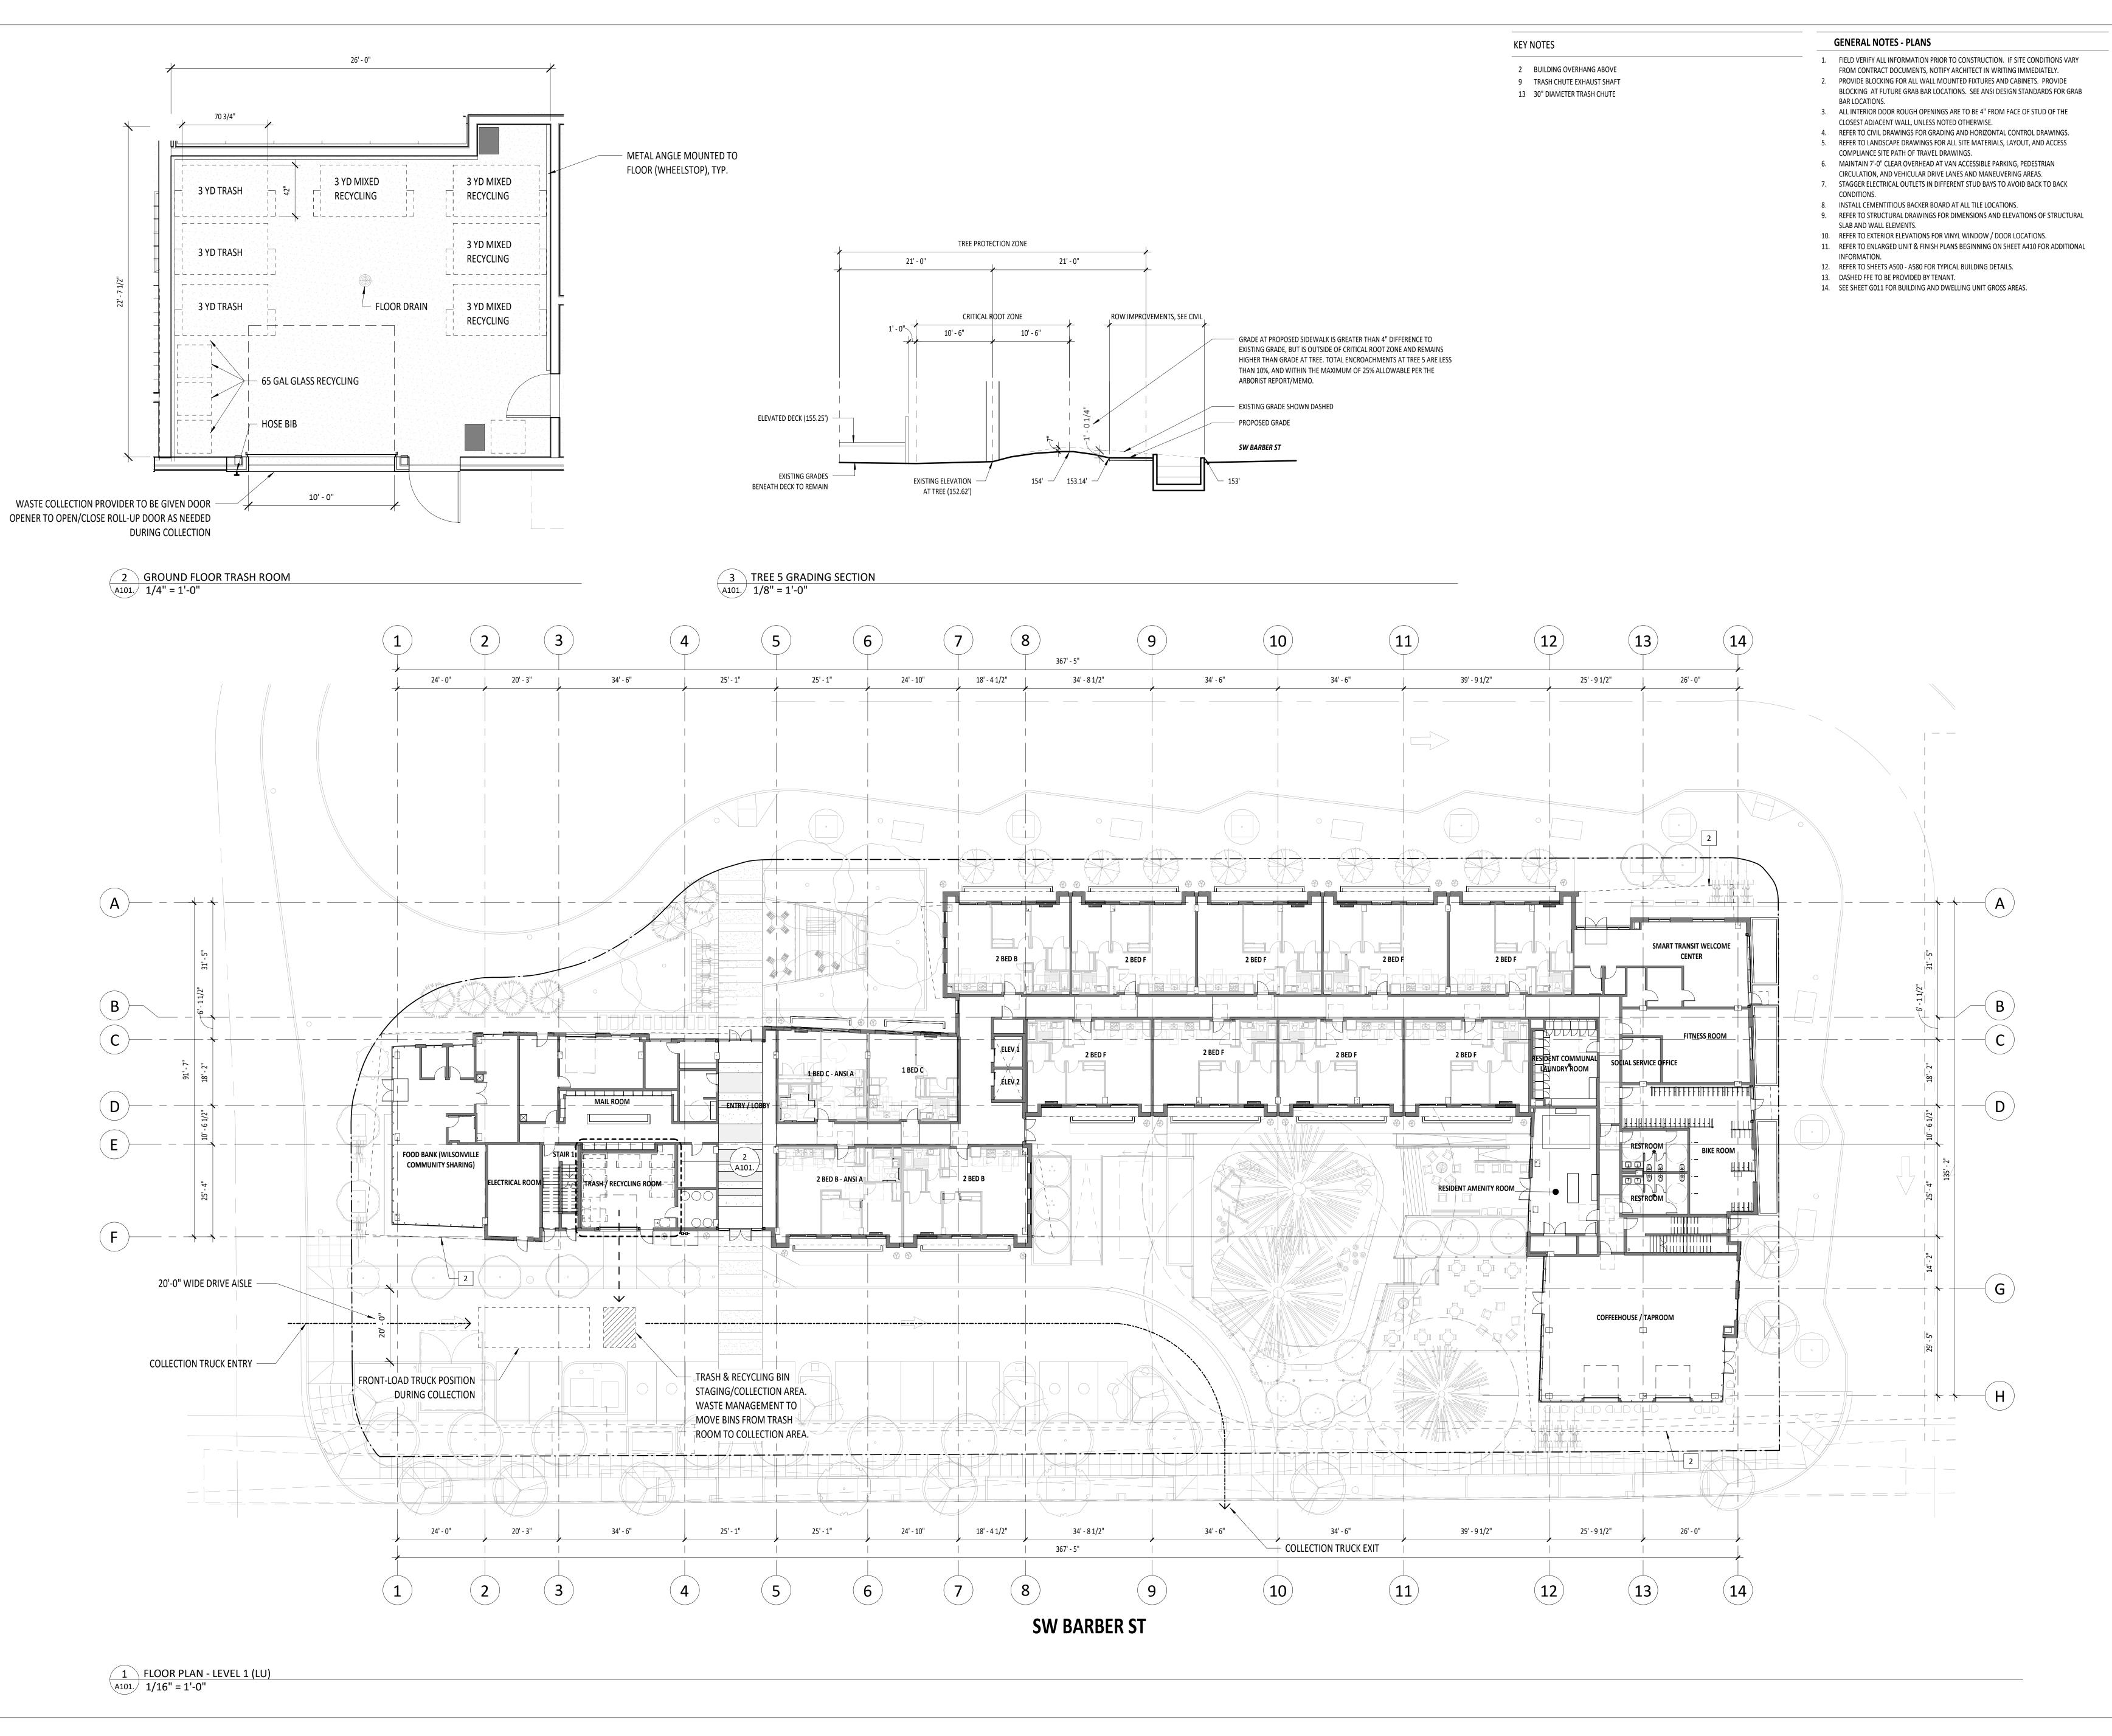



FOR REFERENCE ONLY

SHEET REVISION REVISION NO. EVENT

TRUE PLAN NORTH

WILSONVILLE TOD

PALINDROME COMMUNITIES

ISSUANCE
LAND USE REVIEW
PROJECT NUMBER
220120

DATE 08/18/23

FULL SHEET SIZE

30 X 42

30 X 42
DRAWING TITLE

FLOOR PLAN - LEVEL 1 (LU)

SHEET NUMBER


A101.

- 2 BUILDING OVERHANG ABOVE 9 TRASH CHUTE EXHAUST SHAFT


13 30" DIAMETER TRASH CHUTE

GENERAL NOTES - PLANS

- 1. FIELD VERIFY ALL INFORMATION PRIOR TO CONSTRUCTION. IF SITE CONDITIONS VARY FROM CONTRACT DOCUMENTS, NOTIFY ARCHITECT IN WRITING IMMEDIATELY. 2. PROVIDE BLOCKING FOR ALL WALL MOUNTED FIXTURES AND CABINETS. PROVIDE BLOCKING AT FUTURE GRAB BAR LOCATIONS. SEE ANSI DESIGN STANDARDS FOR GRAB
- BAR LOCATIONS. 3. ALL INTERIOR DOOR ROUGH OPENINGS ARE TO BE 4" FROM FACE OF STUD OF THE CLOSEST ADJACENT WALL, UNLESS NOTED OTHERWISE.
- 4. REFER TO CIVIL DRAWINGS FOR GRADING AND HORIZONTAL CONTROL DRAWINGS. 5. REFER TO LANDSCAPE DRAWINGS FOR ALL SITE MATERIALS, LAYOUT, AND ACCESS COMPLIANCE SITE PATH OF TRAVEL DRAWINGS.
- 6. MAINTAIN 7'-0" CLEAR OVERHEAD AT VAN ACCESSIBLE PARKING, PEDESTRIAN CIRCULATION, AND VEHICULAR DRIVE LANES AND MANEUVERING AREAS.
- 7. STAGGER ELECTRICAL OUTLETS IN DIFFERENT STUD BAYS TO AVOID BACK TO BACK CONDITIONS.
- 8. INSTALL CEMENTITIOUS BACKER BOARD AT ALL TILE LOCATIONS. 9. REFER TO STRUCTURAL DRAWINGS FOR DIMENSIONS AND ELEVATIONS OF STRUCTURAL
- 10. REFER TO EXTERIOR ELEVATIONS FOR VINYL WINDOW / DOOR LOCATIONS. 11. REFER TO ENLARGED UNIT & FINISH PLANS BEGINNING ON SHEET A410 FOR ADDITIONAL
- 12. REFER TO SHEETS A500 A580 FOR TYPICAL BUILDING DETAILS.
- 13. DASHED FFE TO BE PROVIDED BY TENANT.
- 14. SEE SHEET G011 FOR BUILDING AND DWELLING UNIT GROSS AREAS.

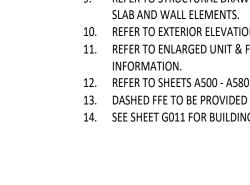



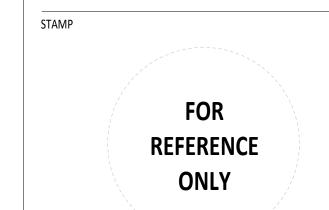

SHEET REVISION REVISION NO. EVENT

TRUE PLAN NORTH WILSONVILLE TOD


PALINDROME COMMUNITIES

PROJECT NUMBER 220120


DATE 08/18/23 FULL SHEET SIZE

30 X 42 DRAWING TITLE FLOOR PLAN - LEVEL 2 (LU)

A102.

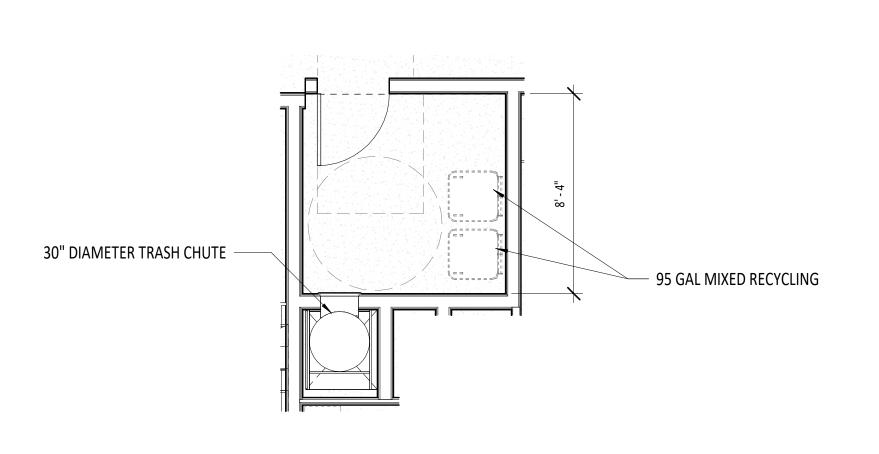


2 TRASH ROOM - UPPER FLOOR, TYP. (LU) A102. 1/4" = 1'-0"

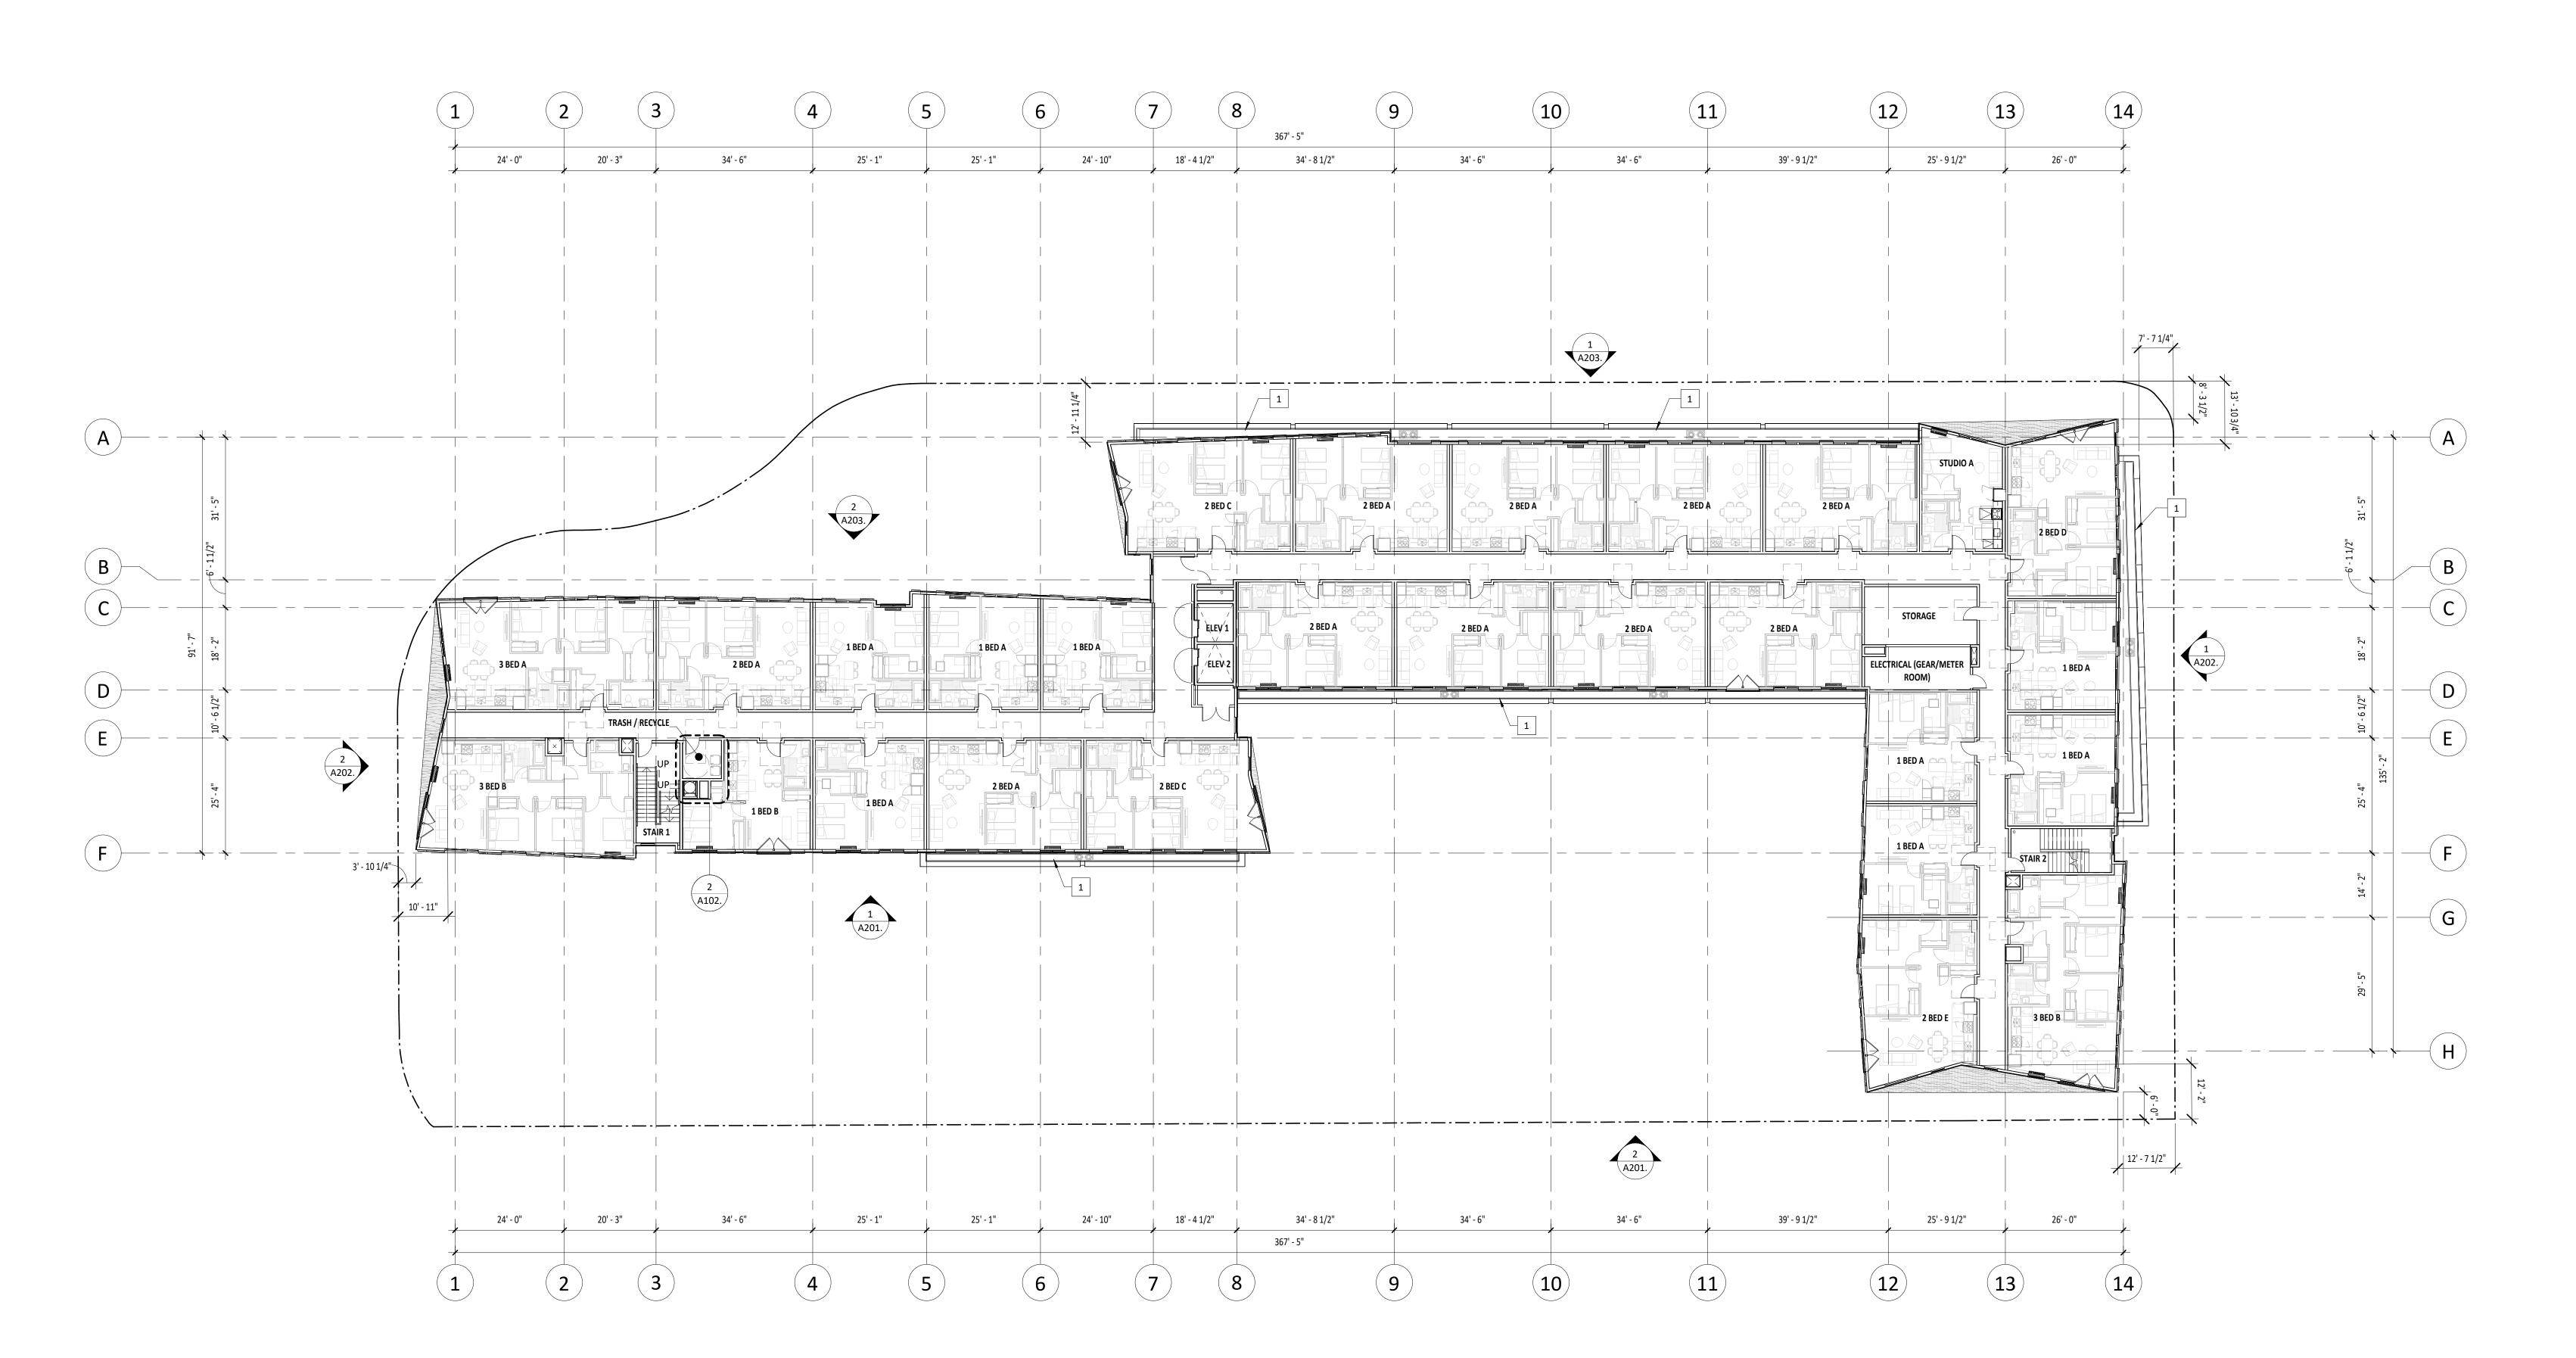

- 1 PREFABRICATED PLANTER SEE LANDSCAPE DRAWINGS
- 2 BUILDING OVERHANG ABOVE
- 3 RECESSED MAILBOX, TYPE 4CADD-10
- 5 MOP SINK, REFERENCE PLUMBING DRAWINGS
- 6 WATER HEATER, REFERENCE PLUMBING DRAWINGS 7 FLOOR-MOUNT BIKE HOOP
- 8 FLOOR-MOUNT HANGING BIKE RACK 9 TRASH CHUTE EXHAUST SHAFT

10 MECHANICAL SHAFT, REFERENCE MECHANICAL

- 11 TYPE I HOOD SHAFT 12 STANDPIPE, FINAL LOCATION TO BE DETERMINED BY FIRE MARSHALL
- 13 30" DIAMETER TRASH CHUTE
- 14 JULIET BALCONY RAILING, REFERENCE ELEVATIONS
- 15 GAS METERS, REFERENCE CIVIL AND PLUMBING DRAWINGS 16 HANDRAIL, 1-1/2" DIAMETER STEEL, INSTALL 36" ABOVE RAMP.
- 17 ELECTRICAL SHAFT, REFERENCE ELECTRICAL DRAWINGS 18 DAS SHAFT, REFERENCE LOW VOLTAGE DRAWINGS
- 4 PARCEL PENDING LOCKERS
- **GENERAL NOTES PLANS** 1. FIELD VERIFY ALL INFORMATION PRIOR TO CONSTRUCTION. IF SITE CONDITIONS VARY FROM CONTRACT DOCUMENTS, NOTIFY ARCHITECT IN WRITING IMMEDIATELY. 2. PROVIDE BLOCKING FOR ALL WALL MOUNTED FIXTURES AND CABINETS. PROVIDE BLOCKING AT FUTURE GRAB BAR LOCATIONS. SEE ANSI DESIGN STANDARDS FOR GRAB
- BAR LOCATIONS. 3. ALL INTERIOR DOOR ROUGH OPENINGS ARE TO BE 4" FROM FACE OF STUD OF THE CLOSEST ADJACENT WALL, UNLESS NOTED OTHERWISE. 4. REFER TO CIVIL DRAWINGS FOR GRADING AND HORIZONTAL CONTROL DRAWINGS.
- 5. REFER TO LANDSCAPE DRAWINGS FOR ALL SITE MATERIALS, LAYOUT, AND ACCESS COMPLIANCE SITE PATH OF TRAVEL DRAWINGS. 6. MAINTAIN 7'-0" CLEAR OVERHEAD AT VAN ACCESSIBLE PARKING, PEDESTRIAN CIRCULATION, AND VEHICULAR DRIVE LANES AND MANEUVERING AREAS.
- 7. STAGGER ELECTRICAL OUTLETS IN DIFFERENT STUD BAYS TO AVOID BACK TO BACK CONDITIONS.
- 8. INSTALL CEMENTITIOUS BACKER BOARD AT ALL TILE LOCATIONS.
- 9. REFER TO STRUCTURAL DRAWINGS FOR DIMENSIONS AND ELEVATIONS OF STRUCTURAL SLAB AND WALL ELEMENTS.
- 10. REFER TO EXTERIOR ELEVATIONS FOR VINYL WINDOW / DOOR LOCATIONS. 11. REFER TO ENLARGED UNIT & FINISH PLANS BEGINNING ON SHEET A410 FOR ADDITIONAL
- 12. REFER TO SHEETS A500 A580 FOR TYPICAL BUILDING DETAILS.
- 13. DASHED FFE TO BE PROVIDED BY TENANT.

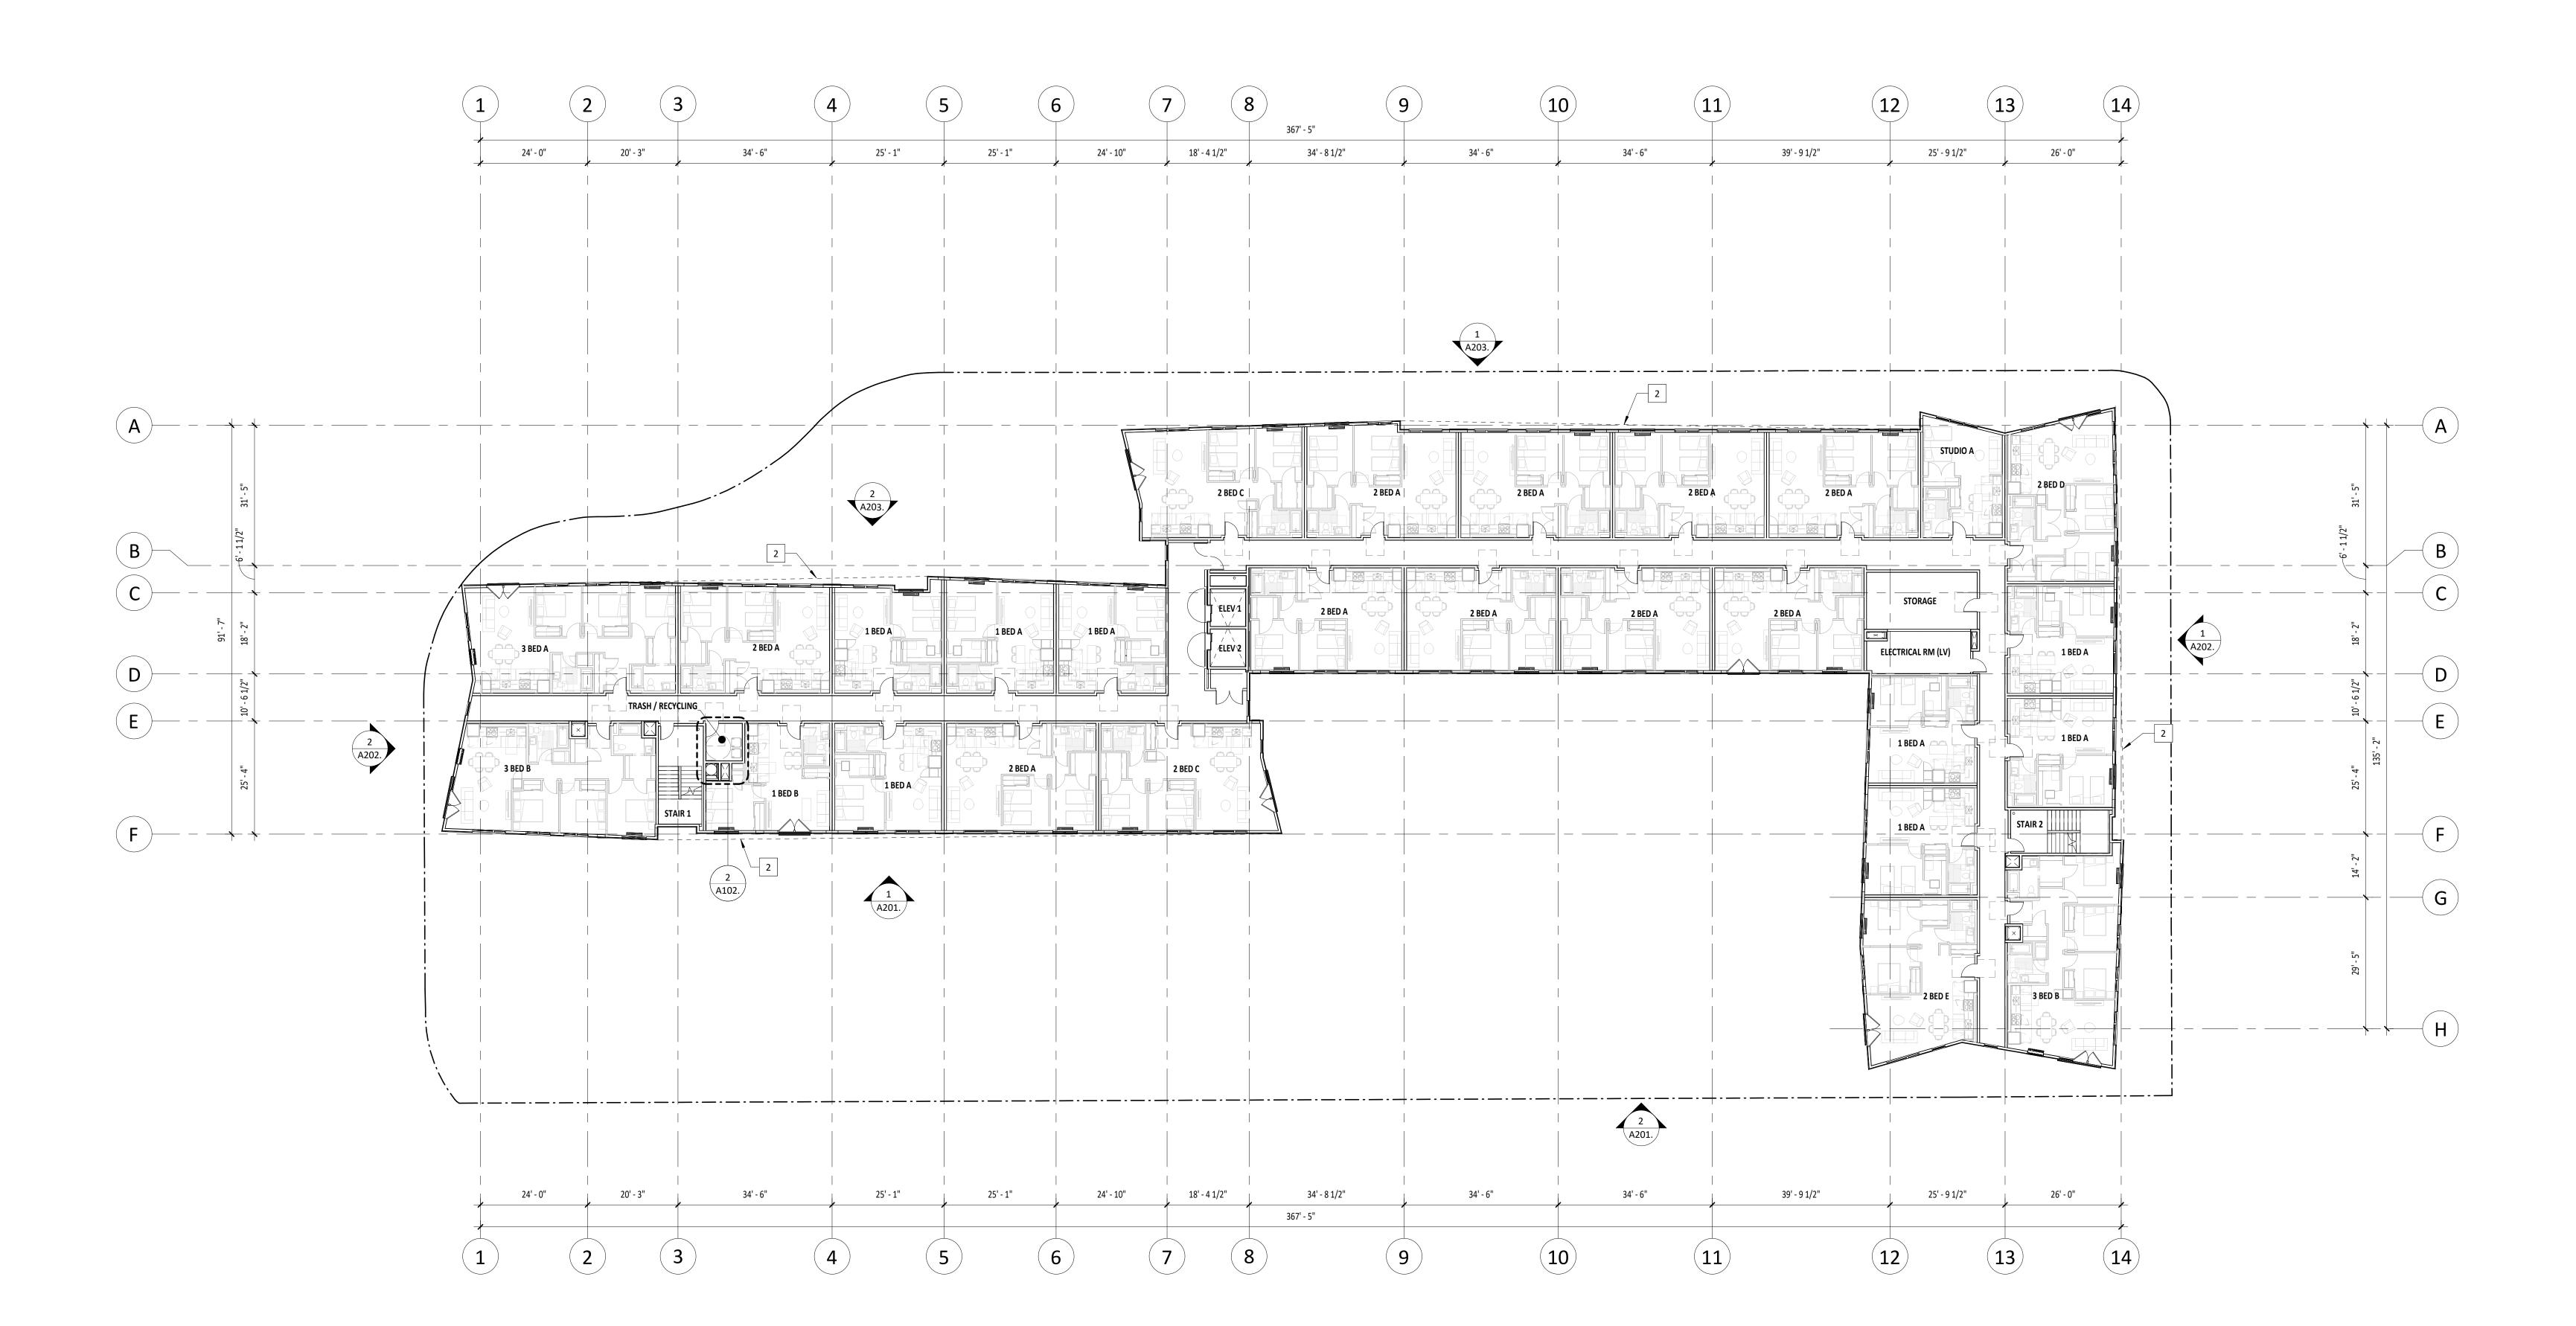

1 FLOOR PLAN - LEVEL 3 (LU)
A103. 1/16" = 1'-0"



REVISION NO. EVENT

WILSONVILLE TOD

PALINDROME COMMUNITIES

PROJECT NUMBER 220120

DATE **08/18/23**

FULL SHEET SIZE 30 X 42 DRAWING TITLE

FLOOR PLAN - LEVEL 3 (LU)

A103.

- 1 PREFABRICATED PLANTER SEE LANDSCAPE DRAWINGS
- 2 BUILDING OVERHANG ABOVE
- 3 RECESSED MAILBOX, TYPE 4CADD-10 4 PARCEL PENDING LOCKERS

8 FLOOR-MOUNT HANGING BIKE RACK


9 TRASH CHUTE EXHAUST SHAFT

- 5 MOP SINK, REFERENCE PLUMBING DRAWINGS
- 6 WATER HEATER, REFERENCE PLUMBING DRAWINGS 7 FLOOR-MOUNT BIKE HOOP
- 10 MECHANICAL SHAFT, REFERENCE MECHANICAL 11 TYPE I HOOD SHAFT
- 12 STANDPIPE, FINAL LOCATION TO BE DETERMINED BY FIRE MARSHALL
- 13 30" DIAMETER TRASH CHUTE
- 14 JULIET BALCONY RAILING, REFERENCE ELEVATIONS
- 15 GAS METERS, REFERENCE CIVIL AND PLUMBING DRAWINGS 16 HANDRAIL, 1-1/2" DIAMETER STEEL, INSTALL 36" ABOVE RAMP.
- 17 ELECTRICAL SHAFT, REFERENCE ELECTRICAL DRAWINGS
- 18 DAS SHAFT, REFERENCE LOW VOLTAGE DRAWINGS

GENERAL NOTES - PLANS

- 1. FIELD VERIFY ALL INFORMATION PRIOR TO CONSTRUCTION. IF SITE CONDITIONS VARY FROM CONTRACT DOCUMENTS, NOTIFY ARCHITECT IN WRITING IMMEDIATELY. 2. PROVIDE BLOCKING FOR ALL WALL MOUNTED FIXTURES AND CABINETS. PROVIDE BLOCKING AT FUTURE GRAB BAR LOCATIONS. SEE ANSI DESIGN STANDARDS FOR GRAB
- BAR LOCATIONS. 3. ALL INTERIOR DOOR ROUGH OPENINGS ARE TO BE 4" FROM FACE OF STUD OF THE CLOSEST ADJACENT WALL, UNLESS NOTED OTHERWISE. 4. REFER TO CIVIL DRAWINGS FOR GRADING AND HORIZONTAL CONTROL DRAWINGS.
- 5. REFER TO LANDSCAPE DRAWINGS FOR ALL SITE MATERIALS, LAYOUT, AND ACCESS COMPLIANCE SITE PATH OF TRAVEL DRAWINGS. 6. MAINTAIN 7'-0" CLEAR OVERHEAD AT VAN ACCESSIBLE PARKING, PEDESTRIAN
- CIRCULATION, AND VEHICULAR DRIVE LANES AND MANEUVERING AREAS. 7. STAGGER ELECTRICAL OUTLETS IN DIFFERENT STUD BAYS TO AVOID BACK TO BACK
- CONDITIONS. 8. INSTALL CEMENTITIOUS BACKER BOARD AT ALL TILE LOCATIONS.
- 9. REFER TO STRUCTURAL DRAWINGS FOR DIMENSIONS AND ELEVATIONS OF STRUCTURAL SLAB AND WALL ELEMENTS. 10. REFER TO EXTERIOR ELEVATIONS FOR VINYL WINDOW / DOOR LOCATIONS.
- 11. REFER TO ENLARGED UNIT & FINISH PLANS BEGINNING ON SHEET A410 FOR ADDITIONAL
- 12. REFER TO SHEETS A500 A580 FOR TYPICAL BUILDING DETAILS.
- 13. DASHED FFE TO BE PROVIDED BY TENANT.



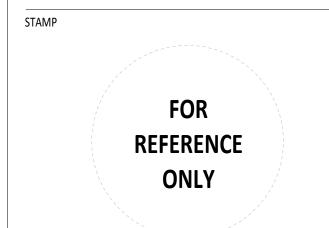

SHEET REVISION REVISION NO. EVENT

TRUE PLAN NORTH WILSONVILLE TOD


PALINDROME COMMUNITIES

PROJECT NUMBER 220120

DATE 08/18/23 FULL SHEET SIZE 30 X 42

DRAWING TITLE FLOOR PLAN - LEVEL 4 (LU)

A104.

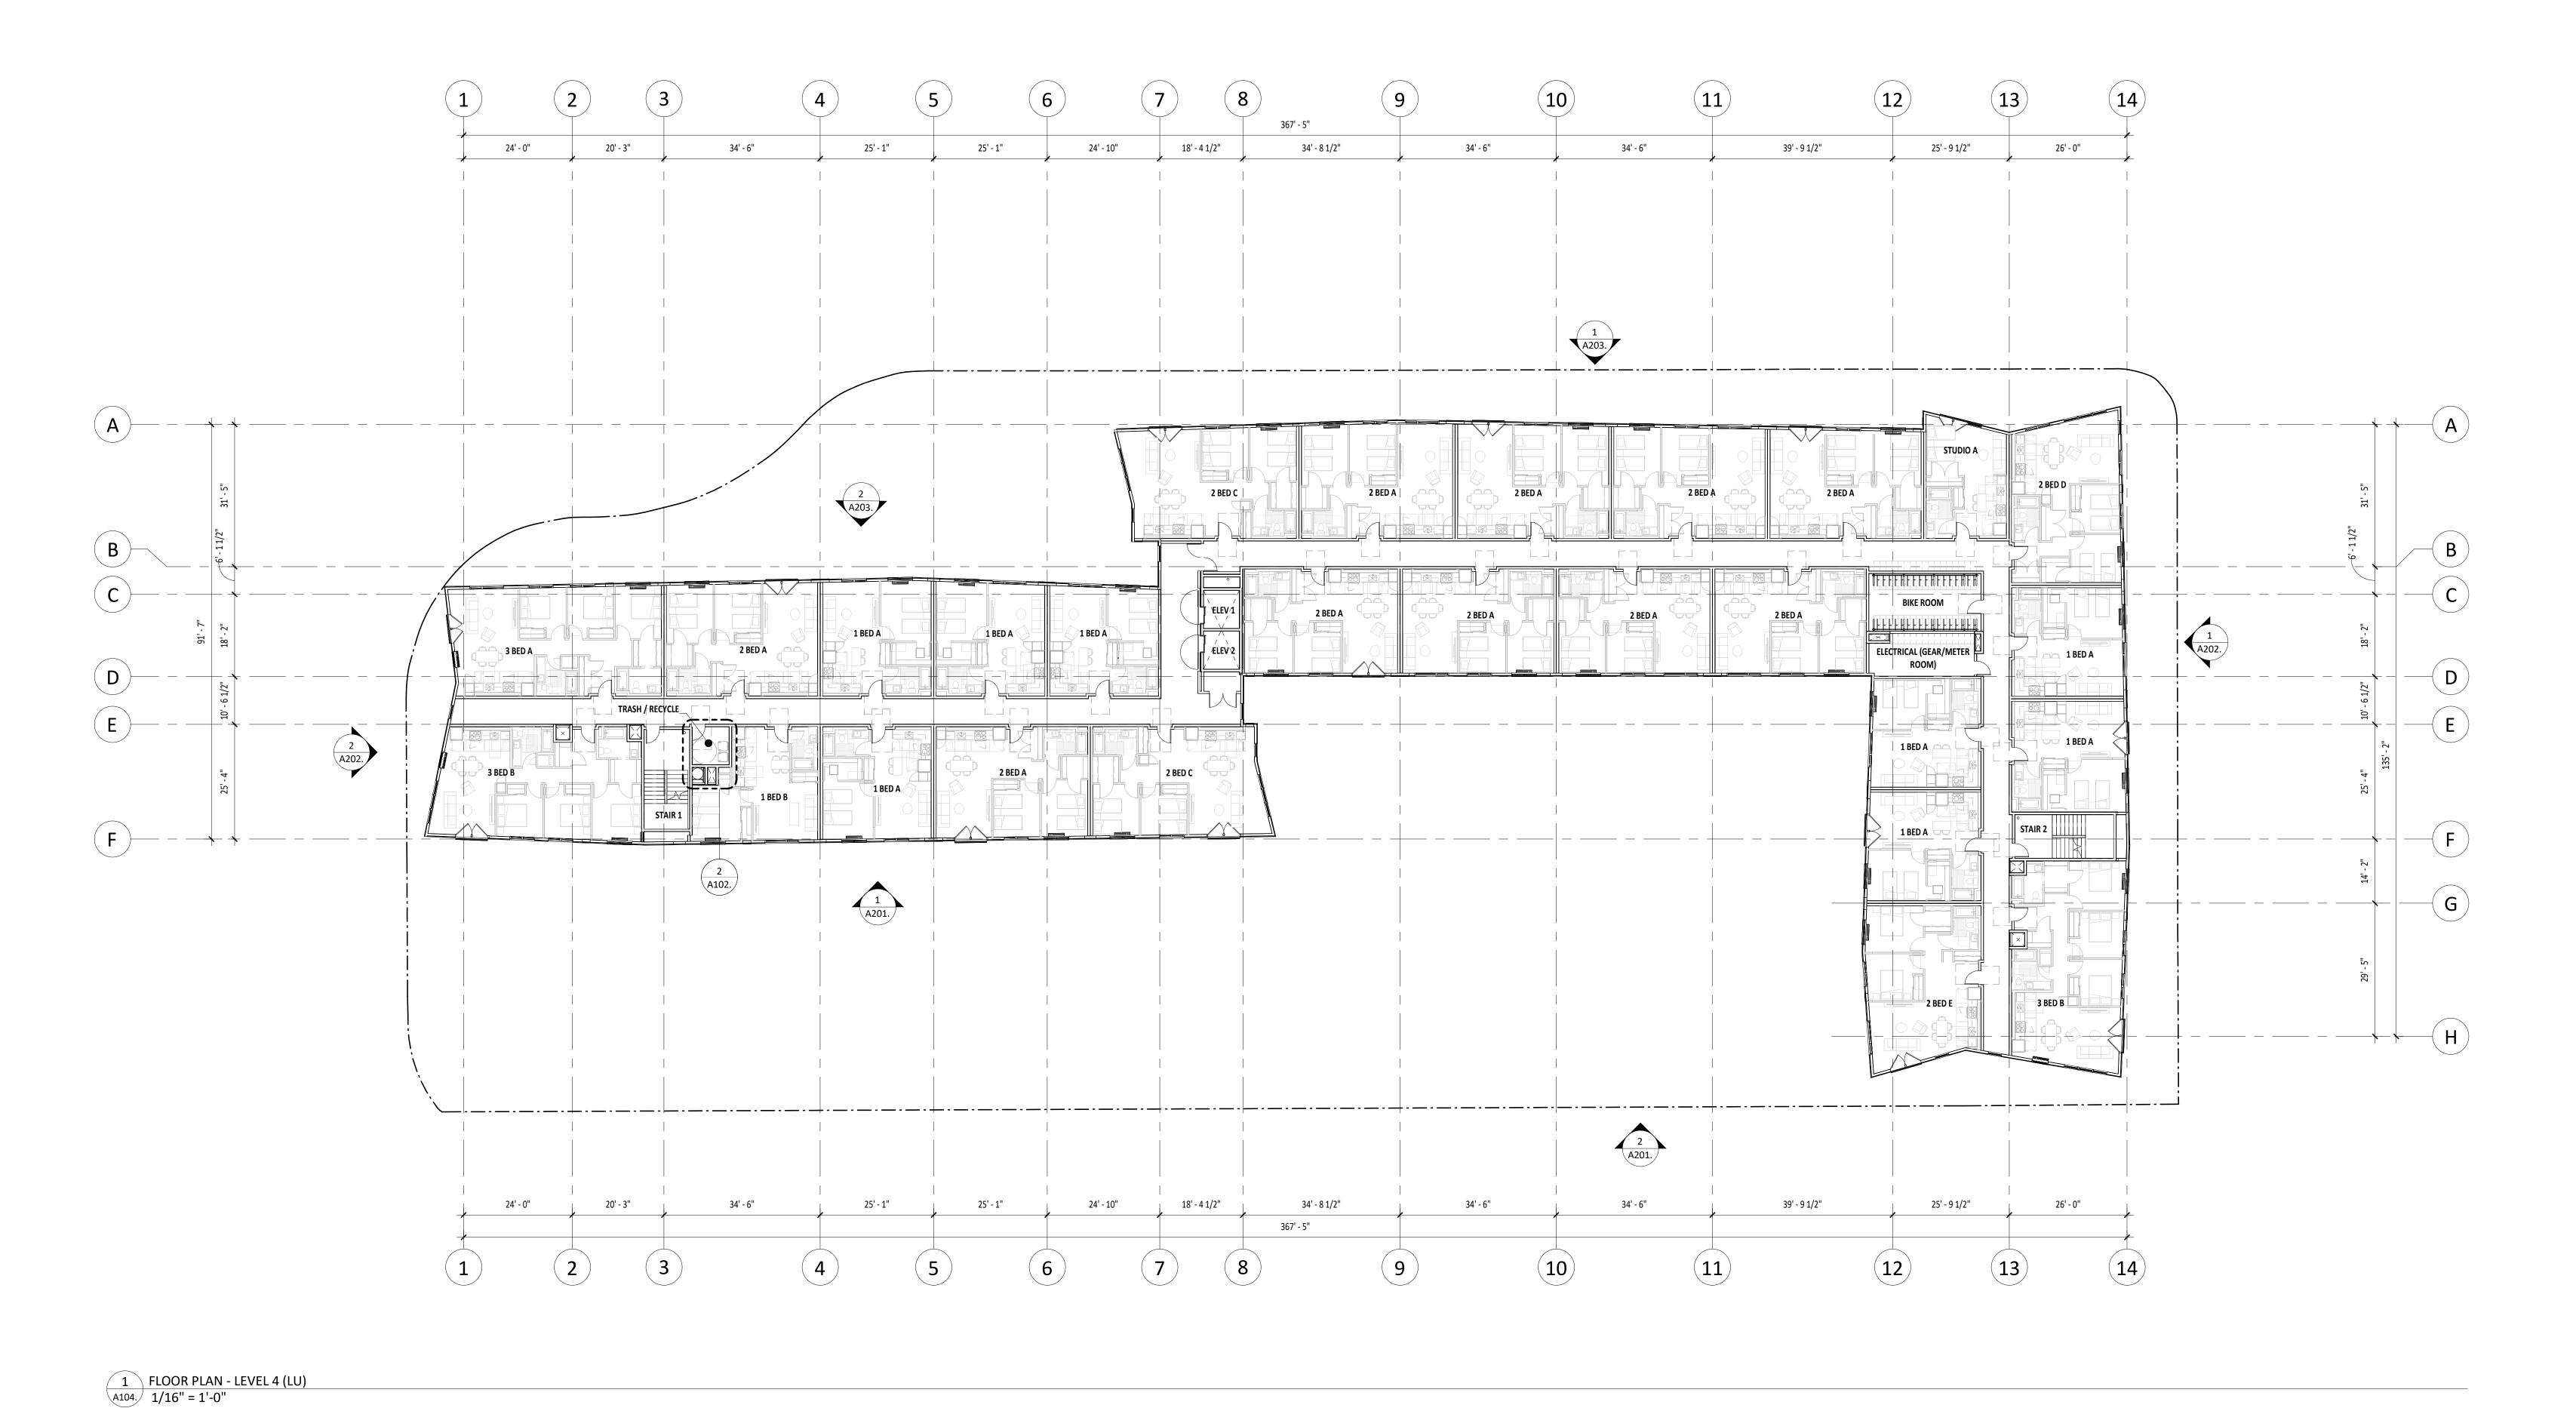


- 1 PREFABRICATED PLANTER SEE LANDSCAPE DRAWINGS
- 2 BUILDING OVERHANG ABOVE 3 RECESSED MAILBOX, TYPE 4CADD-10
- 4 PARCEL PENDING LOCKERS
- 5 MOP SINK, REFERENCE PLUMBING DRAWINGS 6 WATER HEATER, REFERENCE PLUMBING DRAWINGS
- 7 FLOOR-MOUNT BIKE HOOP 8 FLOOR-MOUNT HANGING BIKE RACK 9 TRASH CHUTE EXHAUST SHAFT
- 10 MECHANICAL SHAFT, REFERENCE MECHANICAL 11 TYPE I HOOD SHAFT
- 12 STANDPIPE, FINAL LOCATION TO BE DETERMINED BY FIRE MARSHALL
- 13 30" DIAMETER TRASH CHUTE
- 14 JULIET BALCONY RAILING, REFERENCE ELEVATIONS
- 15 GAS METERS, REFERENCE CIVIL AND PLUMBING DRAWINGS
- 16 HANDRAIL, 1-1/2" DIAMETER STEEL, INSTALL 36" ABOVE RAMP.
- 17 ELECTRICAL SHAFT, REFERENCE ELECTRICAL DRAWINGS 18 DAS SHAFT, REFERENCE LOW VOLTAGE DRAWINGS

GENERAL NOTES - PLANS

- 1. FIELD VERIFY ALL INFORMATION PRIOR TO CONSTRUCTION. IF SITE CONDITIONS VARY FROM CONTRACT DOCUMENTS, NOTIFY ARCHITECT IN WRITING IMMEDIATELY. 2. PROVIDE BLOCKING FOR ALL WALL MOUNTED FIXTURES AND CABINETS. PROVIDE
- BLOCKING AT FUTURE GRAB BAR LOCATIONS. SEE ANSI DESIGN STANDARDS FOR GRAB BAR LOCATIONS. 3. ALL INTERIOR DOOR ROUGH OPENINGS ARE TO BE 4" FROM FACE OF STUD OF THE CLOSEST ADJACENT WALL, UNLESS NOTED OTHERWISE.
- 4. REFER TO CIVIL DRAWINGS FOR GRADING AND HORIZONTAL CONTROL DRAWINGS. 5. REFER TO LANDSCAPE DRAWINGS FOR ALL SITE MATERIALS, LAYOUT, AND ACCESS COMPLIANCE SITE PATH OF TRAVEL DRAWINGS.
- 6. MAINTAIN 7'-0" CLEAR OVERHEAD AT VAN ACCESSIBLE PARKING, PEDESTRIAN CIRCULATION, AND VEHICULAR DRIVE LANES AND MANEUVERING AREAS. 7. STAGGER ELECTRICAL OUTLETS IN DIFFERENT STUD BAYS TO AVOID BACK TO BACK
- CONDITIONS. 8. INSTALL CEMENTITIOUS BACKER BOARD AT ALL TILE LOCATIONS.
- 9. REFER TO STRUCTURAL DRAWINGS FOR DIMENSIONS AND ELEVATIONS OF STRUCTURAL SLAB AND WALL ELEMENTS.
- 10. REFER TO EXTERIOR ELEVATIONS FOR VINYL WINDOW / DOOR LOCATIONS. 11. REFER TO ENLARGED UNIT & FINISH PLANS BEGINNING ON SHEET A410 FOR ADDITIONAL
- 12. REFER TO SHEETS A500 A580 FOR TYPICAL BUILDING DETAILS.
- 13. DASHED FFE TO BE PROVIDED BY TENANT.



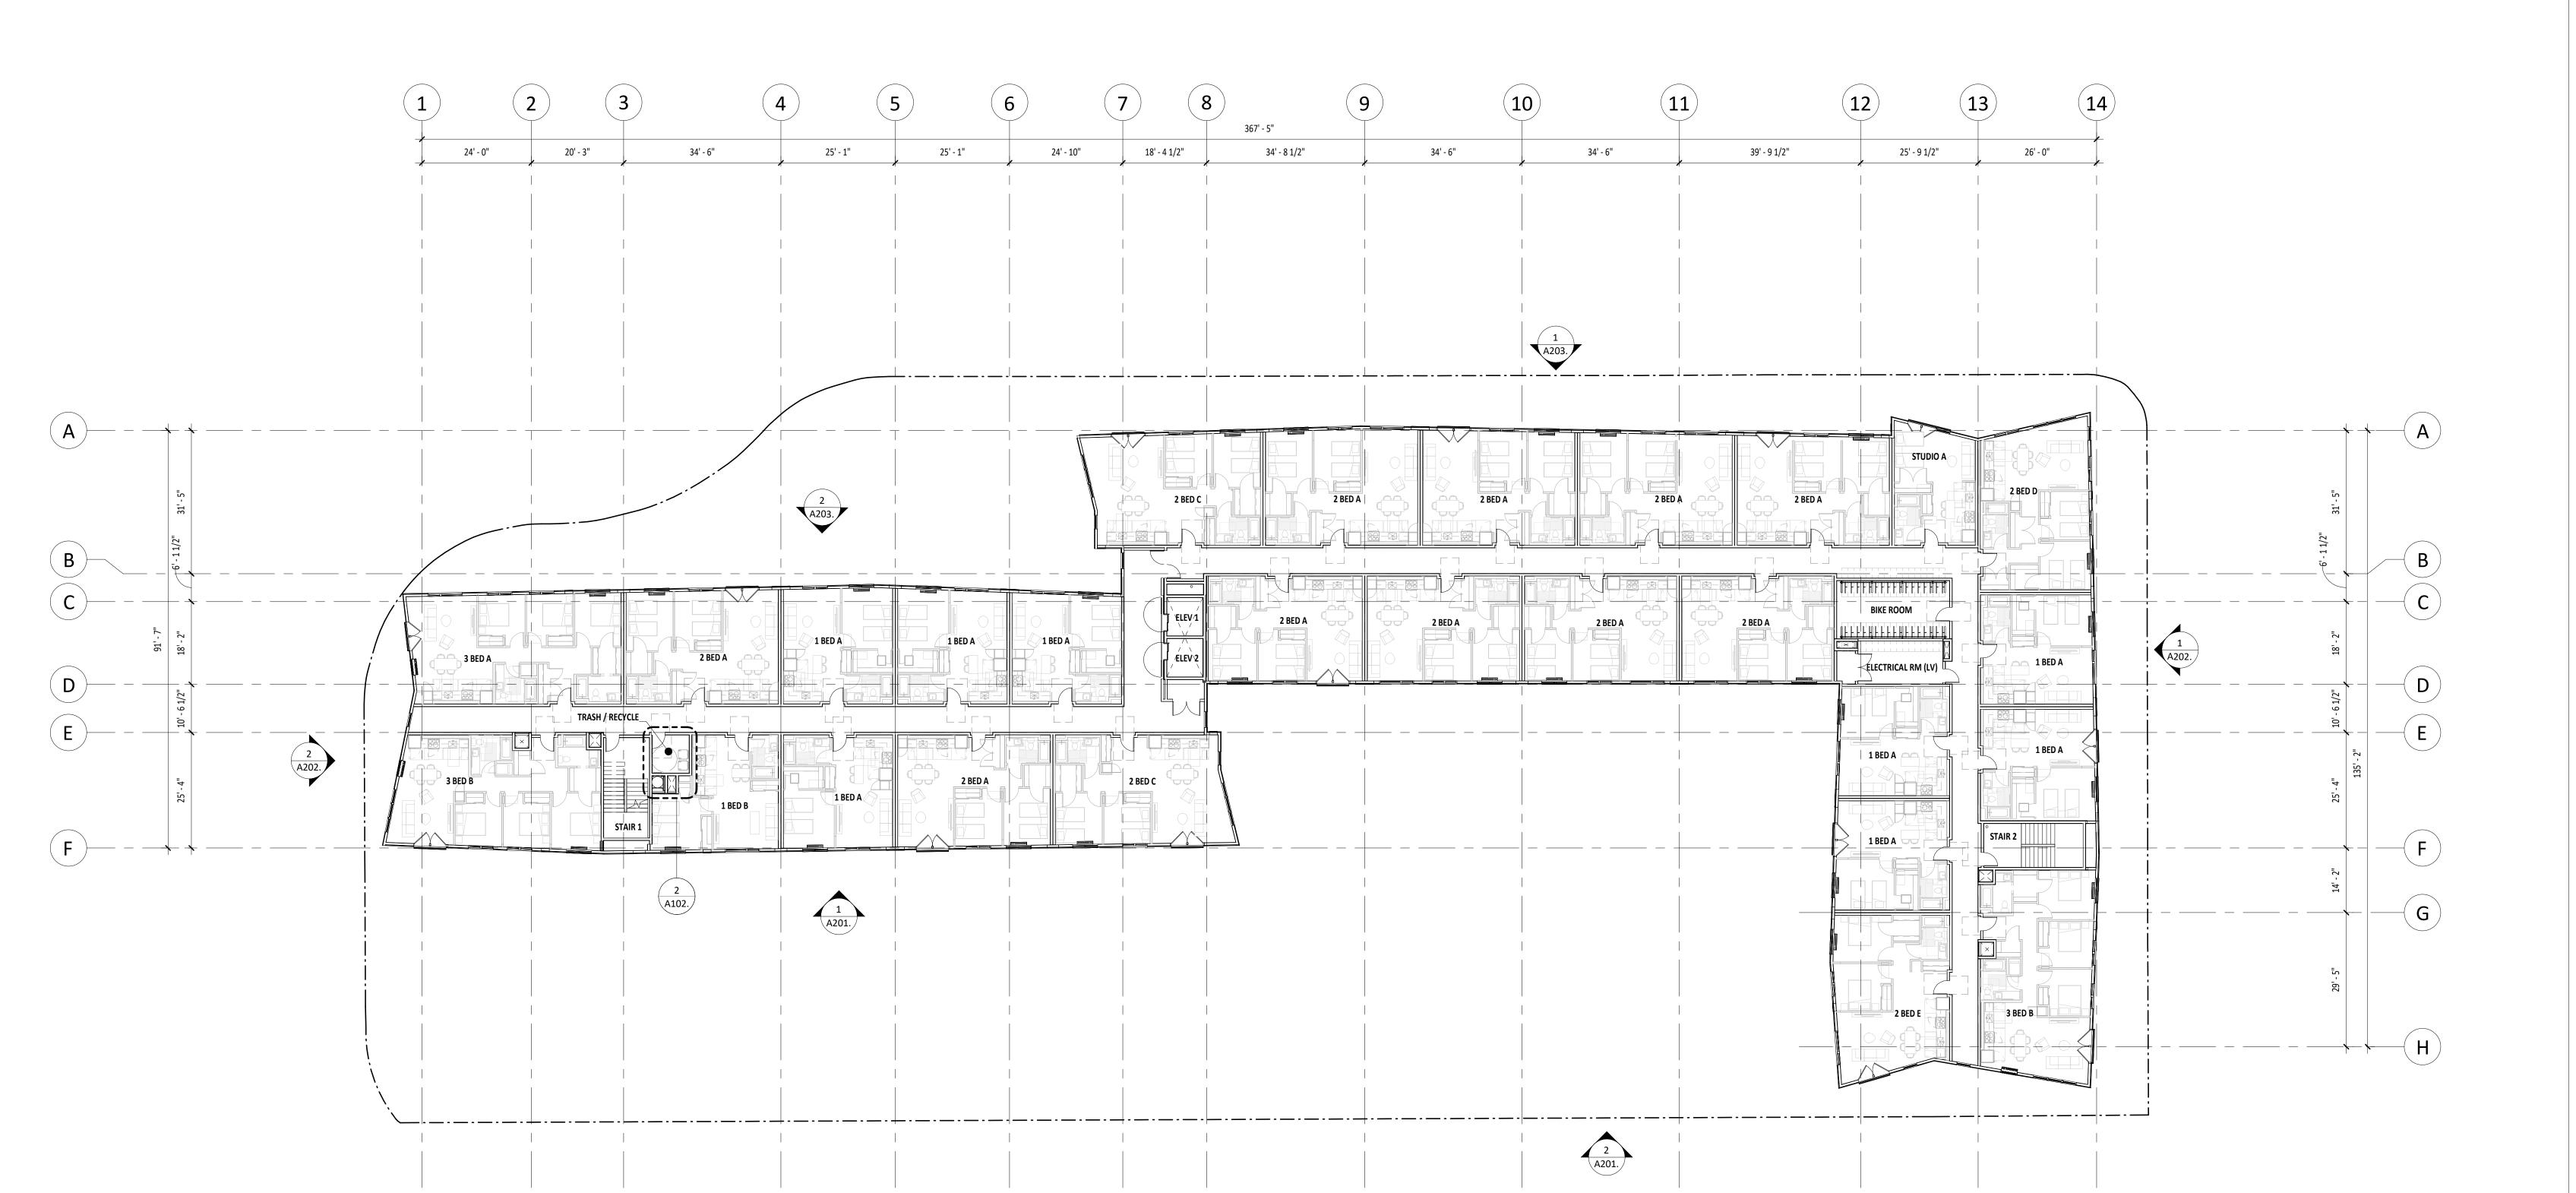

18' - 4 1/2"

24' - 10"

25' - 1"

25' - 1"

34' - 6"

2

1 FLOOR PLAN - LEVEL 5 (LU) A105. 1/16" = 1'-0"

34' - 8 1/2"

367' - 5"

34' - 6"

10

34' - 6"

11

39' - 9 1/2"

25' - 9 1/2"

26' - 0"

13

SHEET REVISION REVISION NO. EVENT

TRUE PLAN NORTH WILSONVILLE TOD

PALINDROME COMMUNITIES

PROJECT NUMBER 220120

DATE **08/18/23**

FULL SHEET SIZE 30 X 42 DRAWING TITLE

FLOOR PLAN - LEVEL 5 (LU)

A105.

- 1 ROOF ACCESS HATCH
- 2 ELEVATOR OVERRUN
- 3 ROOF DRAIN WITH OVERFLOW, REFERENCE PLUMBING
- 4 PV ARRAY 5 STAIR OVERRUN - FULL STAIR ACCESS TO ROOF
- 6 MECHANICAL CURB 7 MECHANICAL ROOFTOP UNIT, REFERENCE MECHANICAL
- 9 36" WIDE NON-SLIP WALKING SURFACE
- 8 MECHANICAL DUCT, REFERENCE MECHANICAL
- COMPLIANCE SITE PATH OF TRAVEL DRAWINGS. 6. MAINTAIN 7'-0" CLEAR OVERHEAD AT VAN ACCESSIBLE PARKING, PEDESTRIAN CIRCULATION, AND VEHICULAR DRIVE LANES AND MANEUVERING AREAS.

CLOSEST ADJACENT WALL, UNLESS NOTED OTHERWISE.

GENERAL NOTES - PLANS

BAR LOCATIONS.

7. STAGGER ELECTRICAL OUTLETS IN DIFFERENT STUD BAYS TO AVOID BACK TO BACK

3. ALL INTERIOR DOOR ROUGH OPENINGS ARE TO BE 4" FROM FACE OF STUD OF THE


4. REFER TO CIVIL DRAWINGS FOR GRADING AND HORIZONTAL CONTROL DRAWINGS. 5. REFER TO LANDSCAPE DRAWINGS FOR ALL SITE MATERIALS, LAYOUT, AND ACCESS

1. FIELD VERIFY ALL INFORMATION PRIOR TO CONSTRUCTION. IF SITE CONDITIONS VARY

FROM CONTRACT DOCUMENTS, NOTIFY ARCHITECT IN WRITING IMMEDIATELY. 2. PROVIDE BLOCKING FOR ALL WALL MOUNTED FIXTURES AND CABINETS. PROVIDE

BLOCKING AT FUTURE GRAB BAR LOCATIONS. SEE ANSI DESIGN STANDARDS FOR GRAB

- CONDITIONS. 8. INSTALL CEMENTITIOUS BACKER BOARD AT ALL TILE LOCATIONS.
- 9. REFER TO STRUCTURAL DRAWINGS FOR DIMENSIONS AND ELEVATIONS OF STRUCTURAL SLAB AND WALL ELEMENTS.
- 10. REFER TO EXTERIOR ELEVATIONS FOR VINYL WINDOW / DOOR LOCATIONS. 11. REFER TO ENLARGED UNIT & FINISH PLANS BEGINNING ON SHEET A410 FOR ADDITIONAL
- 12. REFER TO SHEETS A500 A580 FOR TYPICAL BUILDING DETAILS. 13. DASHED FFE TO BE PROVIDED BY TENANT.

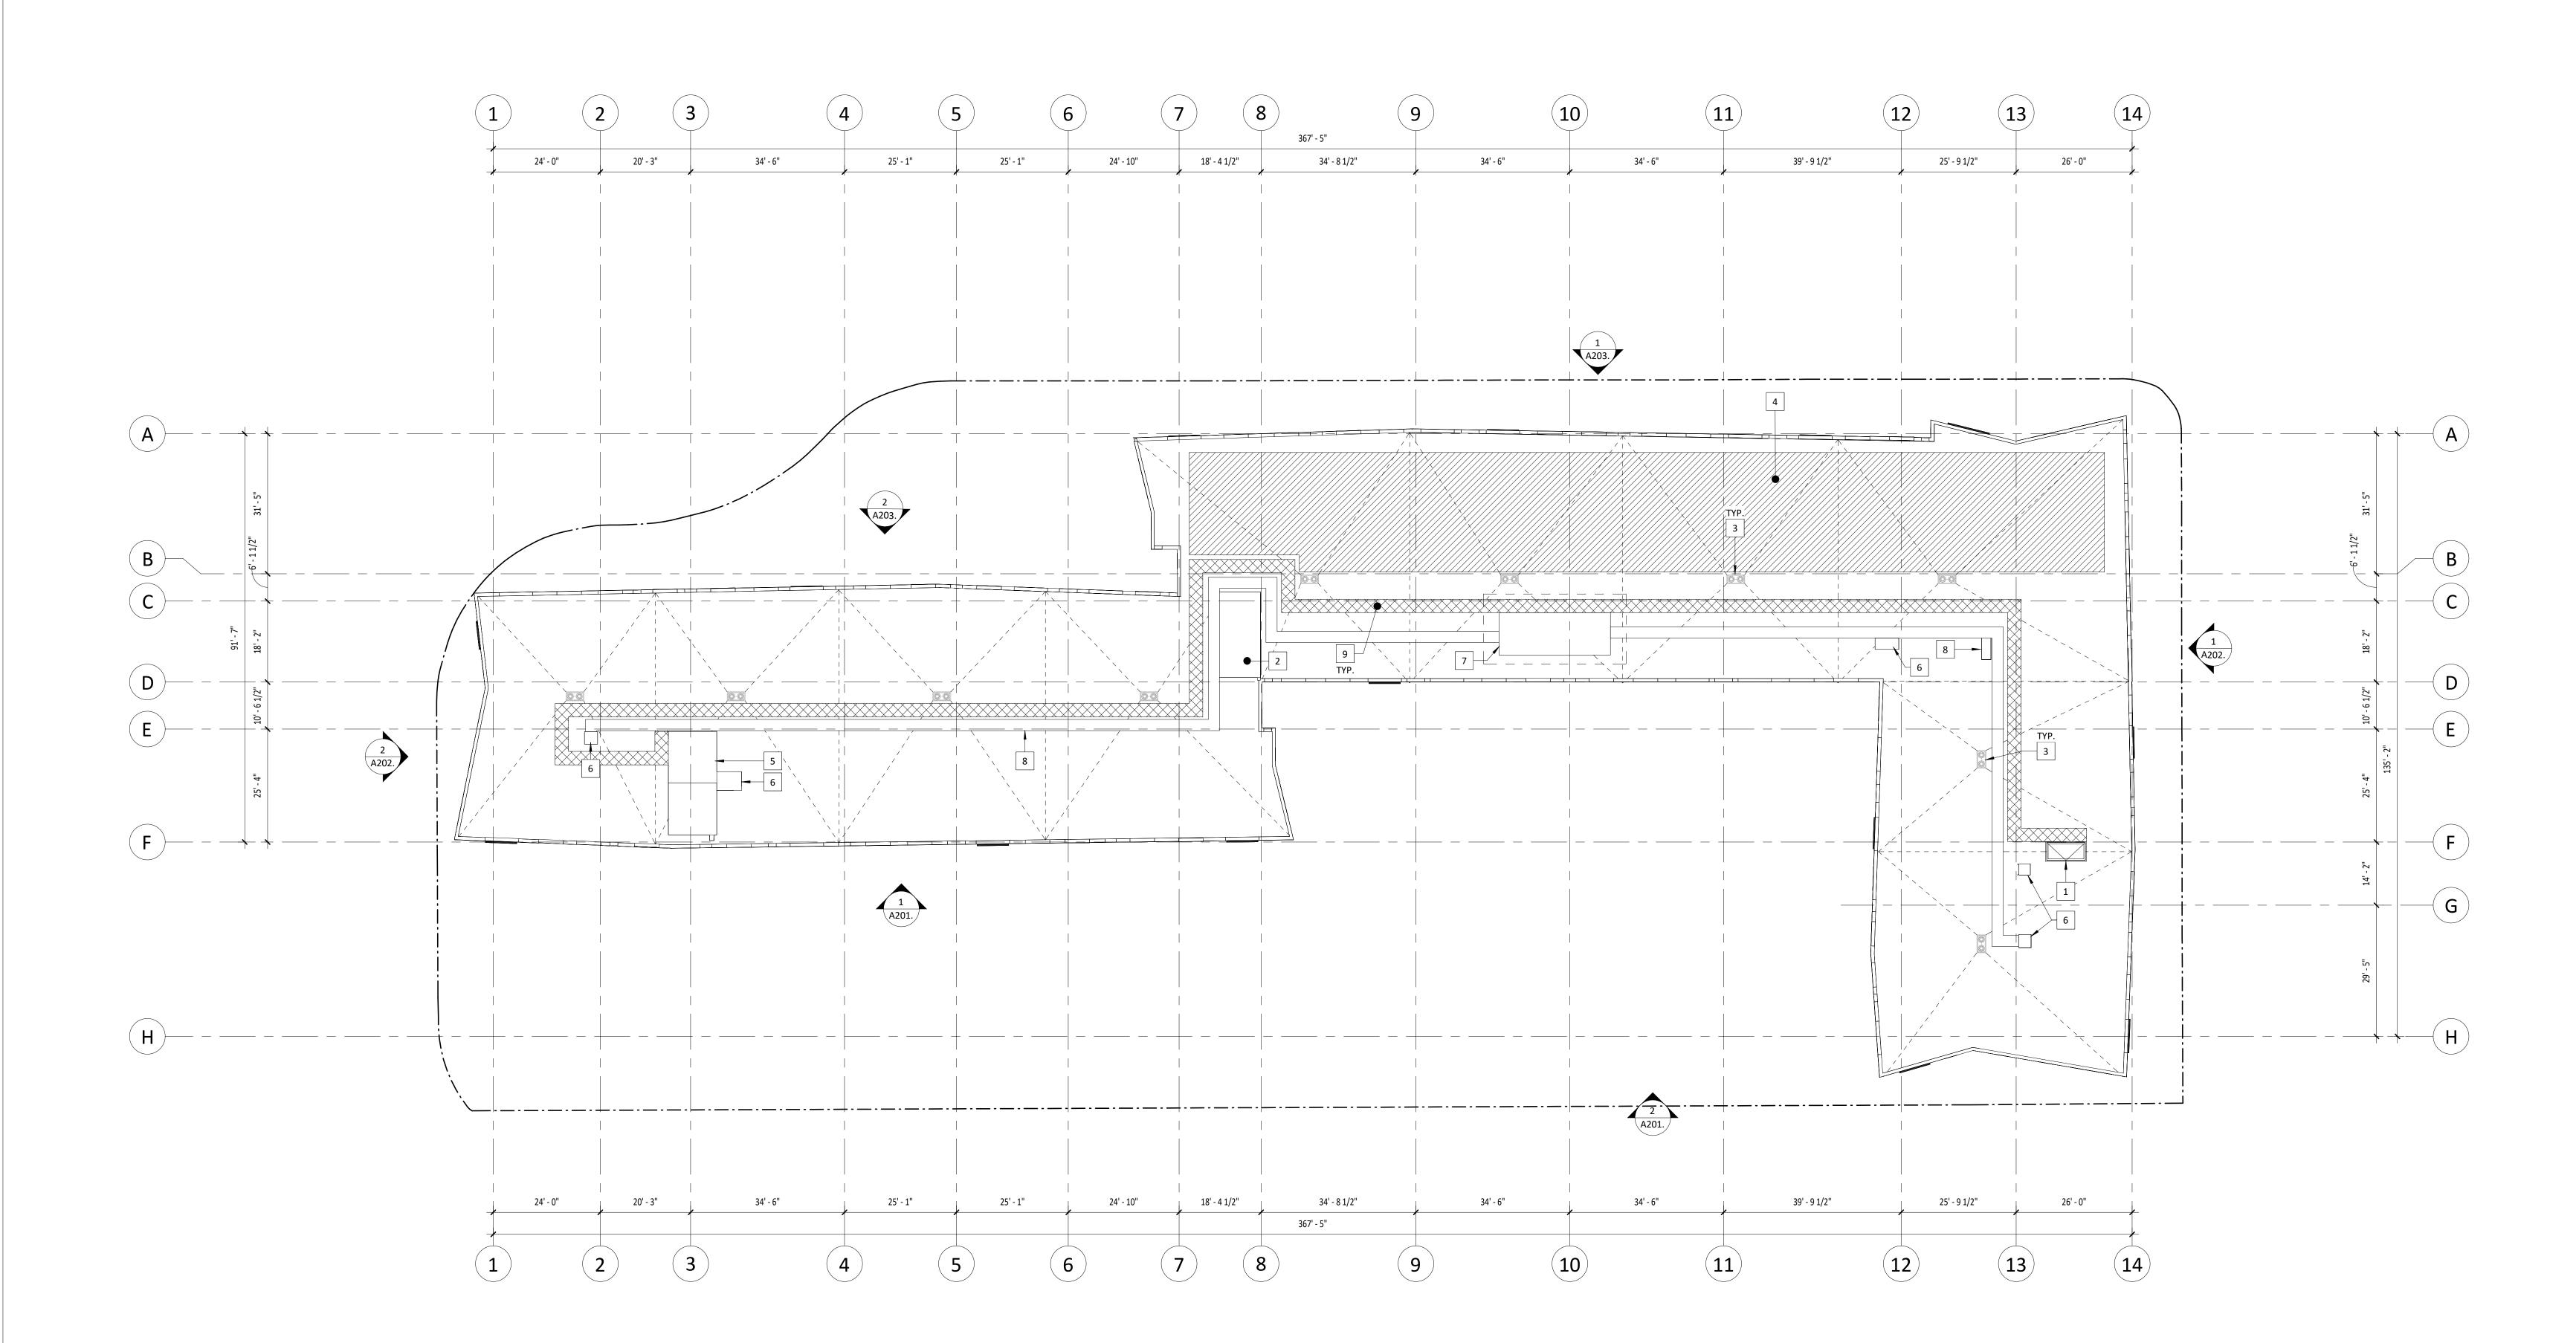

1 ROOF PLAN (LU) A106. 1/16" = 1'-0"



REVISION NO. EVENT

PALINDROME COMMUNITIES

WILSONVILLE TOD

PROJECT NUMBER

220120 DATE 08/18/23

FULL SHEET SIZE

30 X 42 DRAWING TITLE ROOF PLAN (LU)

A106.

- NOTE: SEE SHEET A900 FOR IMAGES OF PROPOSED EXTERIOR MATERIALS & ADDITIONAL INFORMATION NOT SHOWN HERE.
- 1. BRICK VENEER 1
- BRICK VENEER 2
- 3. METAL PANEL 1 4. METAL PANEL 2
- METAL PANEL 3
- COMPOSITE WOOD PLANK CLADDING 7. 18" TALL BOARD-FORMED CONCRETE WALL, STAINED BLACK
- 8. PERFORATED METAL PANEL AT UNIT INTAKE VENT SLOTS & PTHP EXHAUST MECHANICAL LOUVER, BLACK
- 10. EXTERIOR WALL SCONCE, BLACK
- VINYL WINDOW, BLACK 12. VINYL SWING DOOR, BLACK
- 13. STEEL PICKET BALCONY RAILING, BLACK 14. ALUMINUM STOREFRONT SYSTEM, BLACK
- STEEL PLATE CANOPY, BLACK 16. RAISED DECK PLANTER AT LEVEL 2 - SEE LANDSCAPE DRAWINGS
- 17. GLAZED OVERHEAD DOOR 18. METAL FENCE, REFERENCE LANDSCAPE DRAWINGS

1. REFER TO CIVIL DRAWINGS FOR GRADING.

GENERAL NOTES - EXTERIOR ELEVATIONS

- 2. FIELD VERIFY ALL INFORMATION PRIOR TO CONSTRUCTION. IF SITE CONDITIONS VARY
- FROM CONTRACT DOCUMENTS, NOTIFY ARCHITECT IN WRITING IMMEDIATELY. 3. SEE PLANS FOR ALL DOOR TAGS.



REFERENCE

ONLY

REVISION NO. EVENT

REVISION DATE



SOUTH ELEVATION 1 - LAND USE REVIEW
1/8" = 1'-0"



WILSONVILLE TOD

PALINDROME COMMUNITIES

LAND USE REVIEW PROJECT NUMBER

220120

TRUE NORTH

DATE **08/18/23**

FULL SHEET SIZE 30 X 42 DRAWING TITLE

EXTERIOR ELEVATIONS

A201

- NOTE: SEE SHEET A900 FOR IMAGES OF PROPOSED EXTERIOR MATERIALS & ADDITIONAL INFORMATION NOT SHOWN HERE.
- 1. BRICK VENEER 1
- 2. BRICK VENEER 2
- 3. METAL PANEL 1 4. METAL PANEL 2
- 5. METAL PANEL 3
- 6. COMPOSITE WOOD PLANK CLADDING
 7. 18" TALL BOARD-FORMED CONCRETE WALL, STAINED BLACK
- 8. PERFORATED METAL PANEL AT UNIT INTAKE VENT SLOTS & PTHP EXHAUST 9. MECHANICAL LOUVER, BLACK
- 10. EXTERIOR WALL SCONCE, BLACK
- 11. VINYL WINDOW, BLACK 12. VINYL SWING DOOR, BLACK
- 13. STEEL PICKET BALCONY RAILING, BLACK 14. ALUMINUM STOREFRONT SYSTEM, BLACK
- 15. STEEL PLATE CANOPY, BLACK 16. RAISED DECK PLANTER AT LEVEL 2 - SEE LANDSCAPE DRAWINGS 17. GLAZED OVERHEAD DOOR
- 18. METAL FENCE, REFERENCE LANDSCAPE DRAWINGS

GENERAL NOTES - EXTERIOR ELEVATIONS

1. REFER TO CIVIL DRAWINGS FOR GRADING.

2. FIELD VERIFY ALL INFORMATION PRIOR TO CONSTRUCTION. IF SITE CONDITIONS VARY

FROM CONTRACT DOCUMENTS, NOTIFY ARCHITECT IN WRITING IMMEDIATELY.

3. SEE PLANS FOR ALL DOOR TAGS.



REFERENCE

ONLY

REVISION NO. EVENT



1 EAST ELEVATION - LAND USE REVIEW 1/8" = 1'-0"



2 WEST ELEVATION - LAND USE REVIEW A202 1/8" = 1'-0"



WILSONVILLE TOD

PALINDROME COMMUNITIES

LAND USE REVIEW PROJECT NUMBER **220120**

DATE 08/18/23 FULL SHEET SIZE 30 X 42

DRAWING TITLE **EXTERIOR ELEVATIONS**

A202

NOTE: SEE SHEET A900 FOR IMAGES OF PROPOSED EXTERIOR MATERIALS & ADDITIONAL INFORMATION NOT SHOWN HERE.

- 1. BRICK VENEER 1
- BRICK VENEER 2
- 3. METAL PANEL 1 4. METAL PANEL 2
- METAL PANEL 3 COMPOSITE WOOD PLANK CLADDING
- 7. 18" TALL BOARD-FORMED CONCRETE WALL, STAINED BLACK 8. PERFORATED METAL PANEL AT UNIT INTAKE VENT SLOTS & PTHP EXHAUST
- MECHANICAL LOUVER, BLACK
- 10. EXTERIOR WALL SCONCE, BLACK
- 11. VINYL WINDOW, BLACK 12. VINYL SWING DOOR, BLACK
- 13. STEEL PICKET BALCONY RAILING, BLACK 14. ALUMINUM STOREFRONT SYSTEM, BLACK
- STEEL PLATE CANOPY, BLACK 16. RAISED DECK PLANTER AT LEVEL 2 - SEE LANDSCAPE DRAWINGS
- 17. GLAZED OVERHEAD DOOR 18. METAL FENCE, REFERENCE LANDSCAPE DRAWINGS

GENERAL NOTES - EXTERIOR ELEVATIONS

1. REFER TO CIVIL DRAWINGS FOR GRADING.

2. FIELD VERIFY ALL INFORMATION PRIOR TO CONSTRUCTION. IF SITE CONDITIONS VARY FROM CONTRACT DOCUMENTS, NOTIFY ARCHITECT IN WRITING IMMEDIATELY.

3. SEE PLANS FOR ALL DOOR TAGS.



REFERENCE

ONLY

REVISION NO. EVENT



NORTH ELEVATION 1 - LAND USE REVIEW
1/8" = 1'-0"



NORTH ELEVATION 2 - LAND USE REVIEW
1/8" = 1'-0"

PALINDROME COMMUNITIES

WILSONVILLE TOD


LAND USE REVIEW PROJECT NUMBER


220120

DATE **08/18/23 FULL SHEET SIZE** 30 X 42

DRAWING TITLE EXTERIOR ELEVATIONS

A203

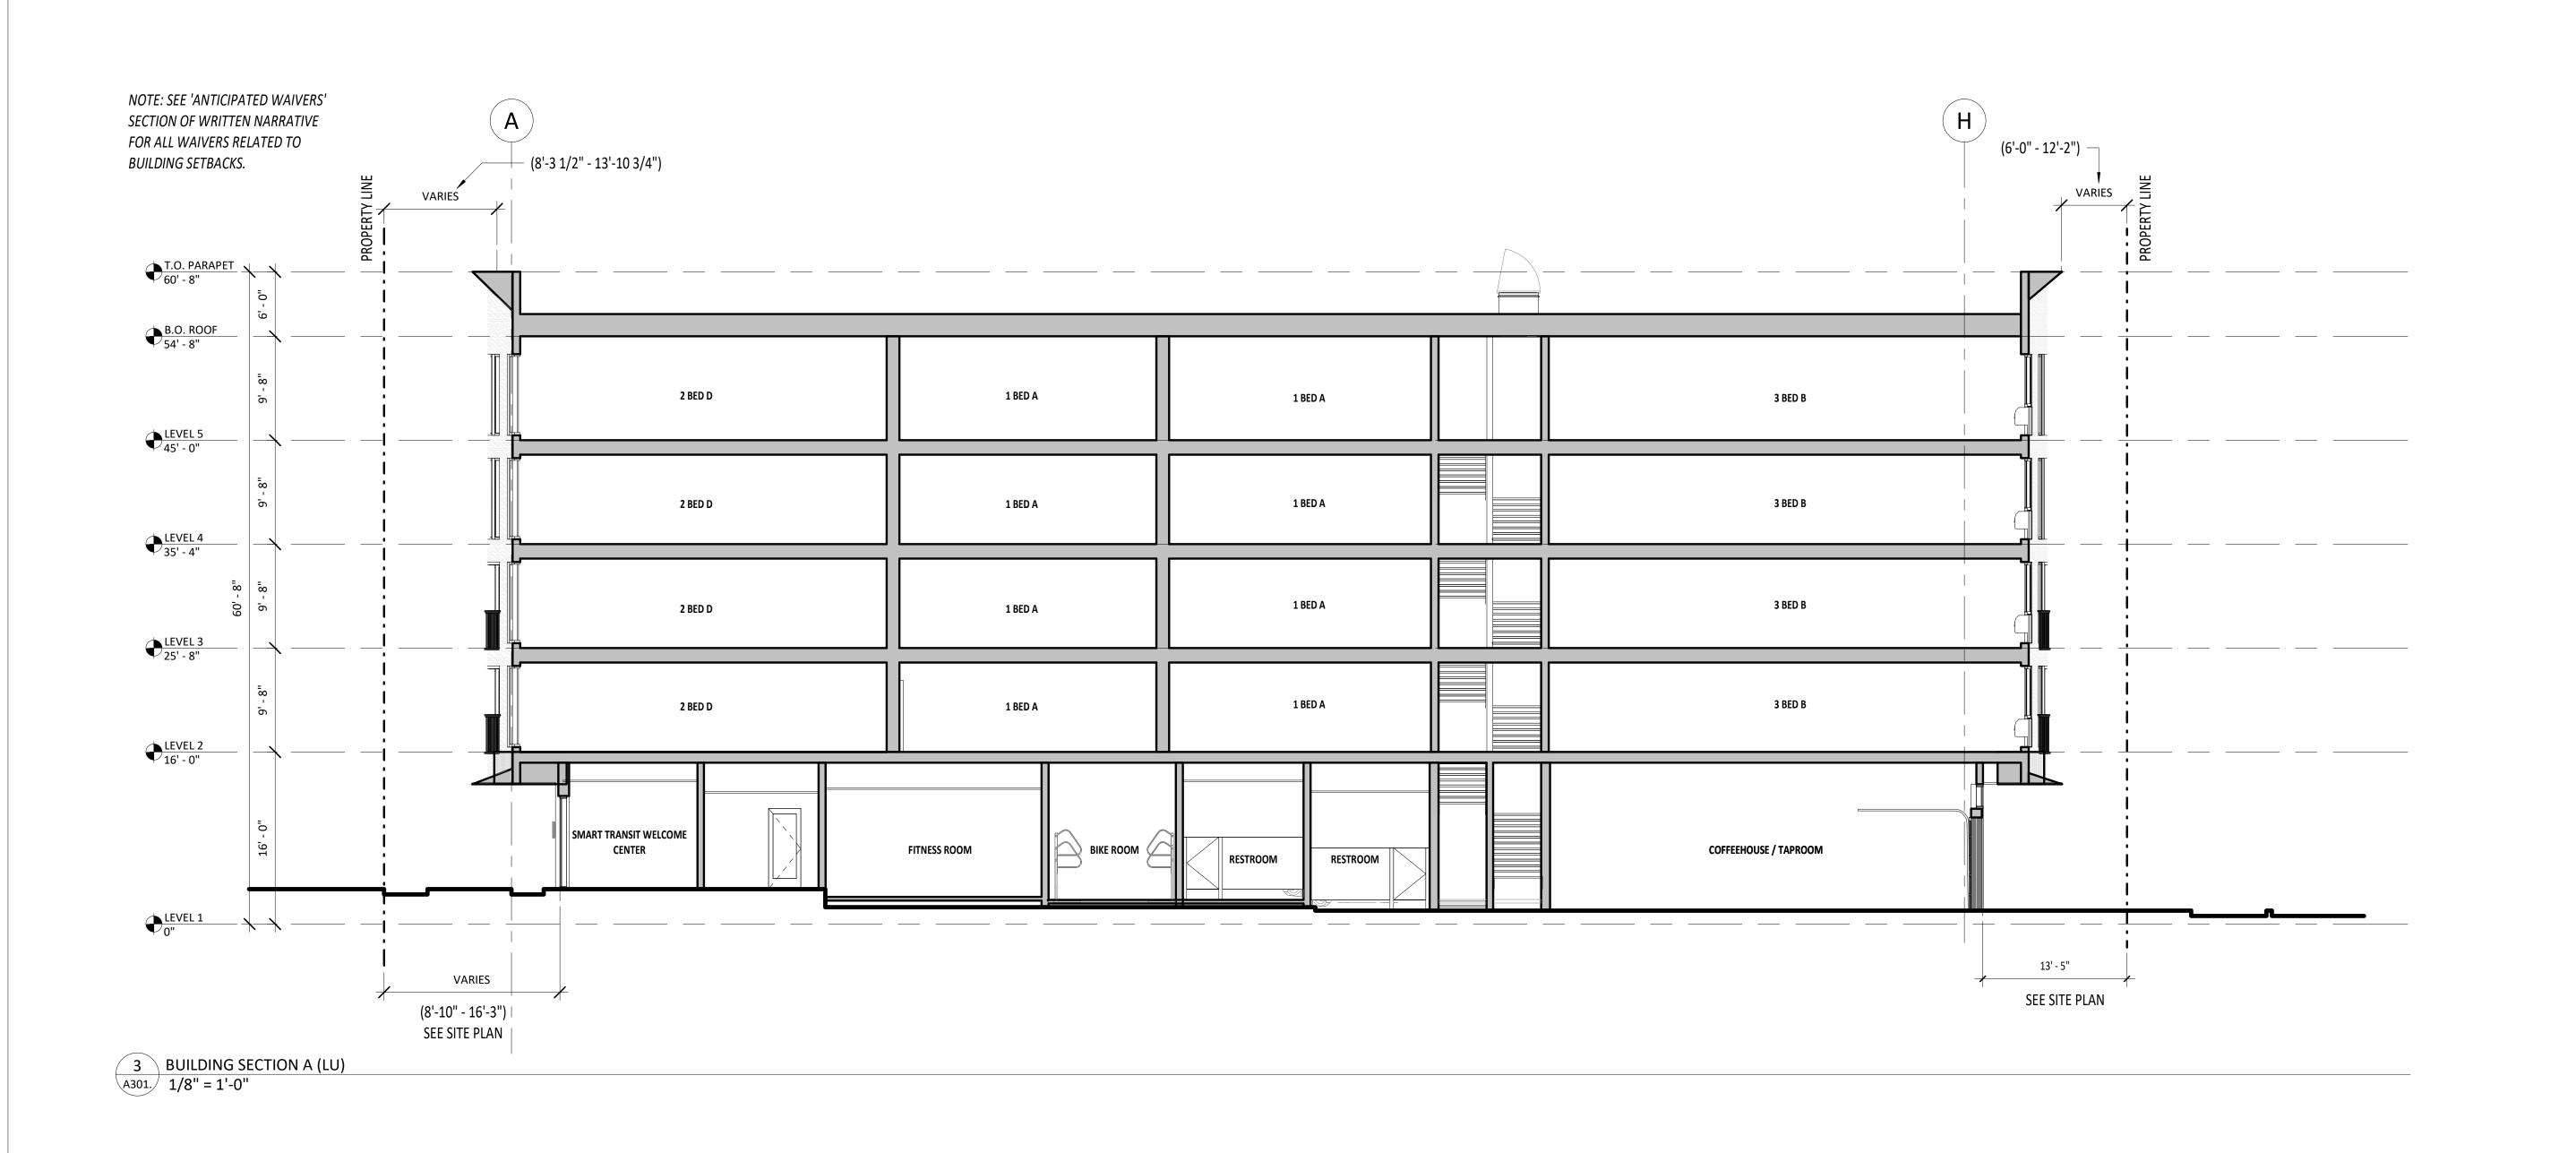

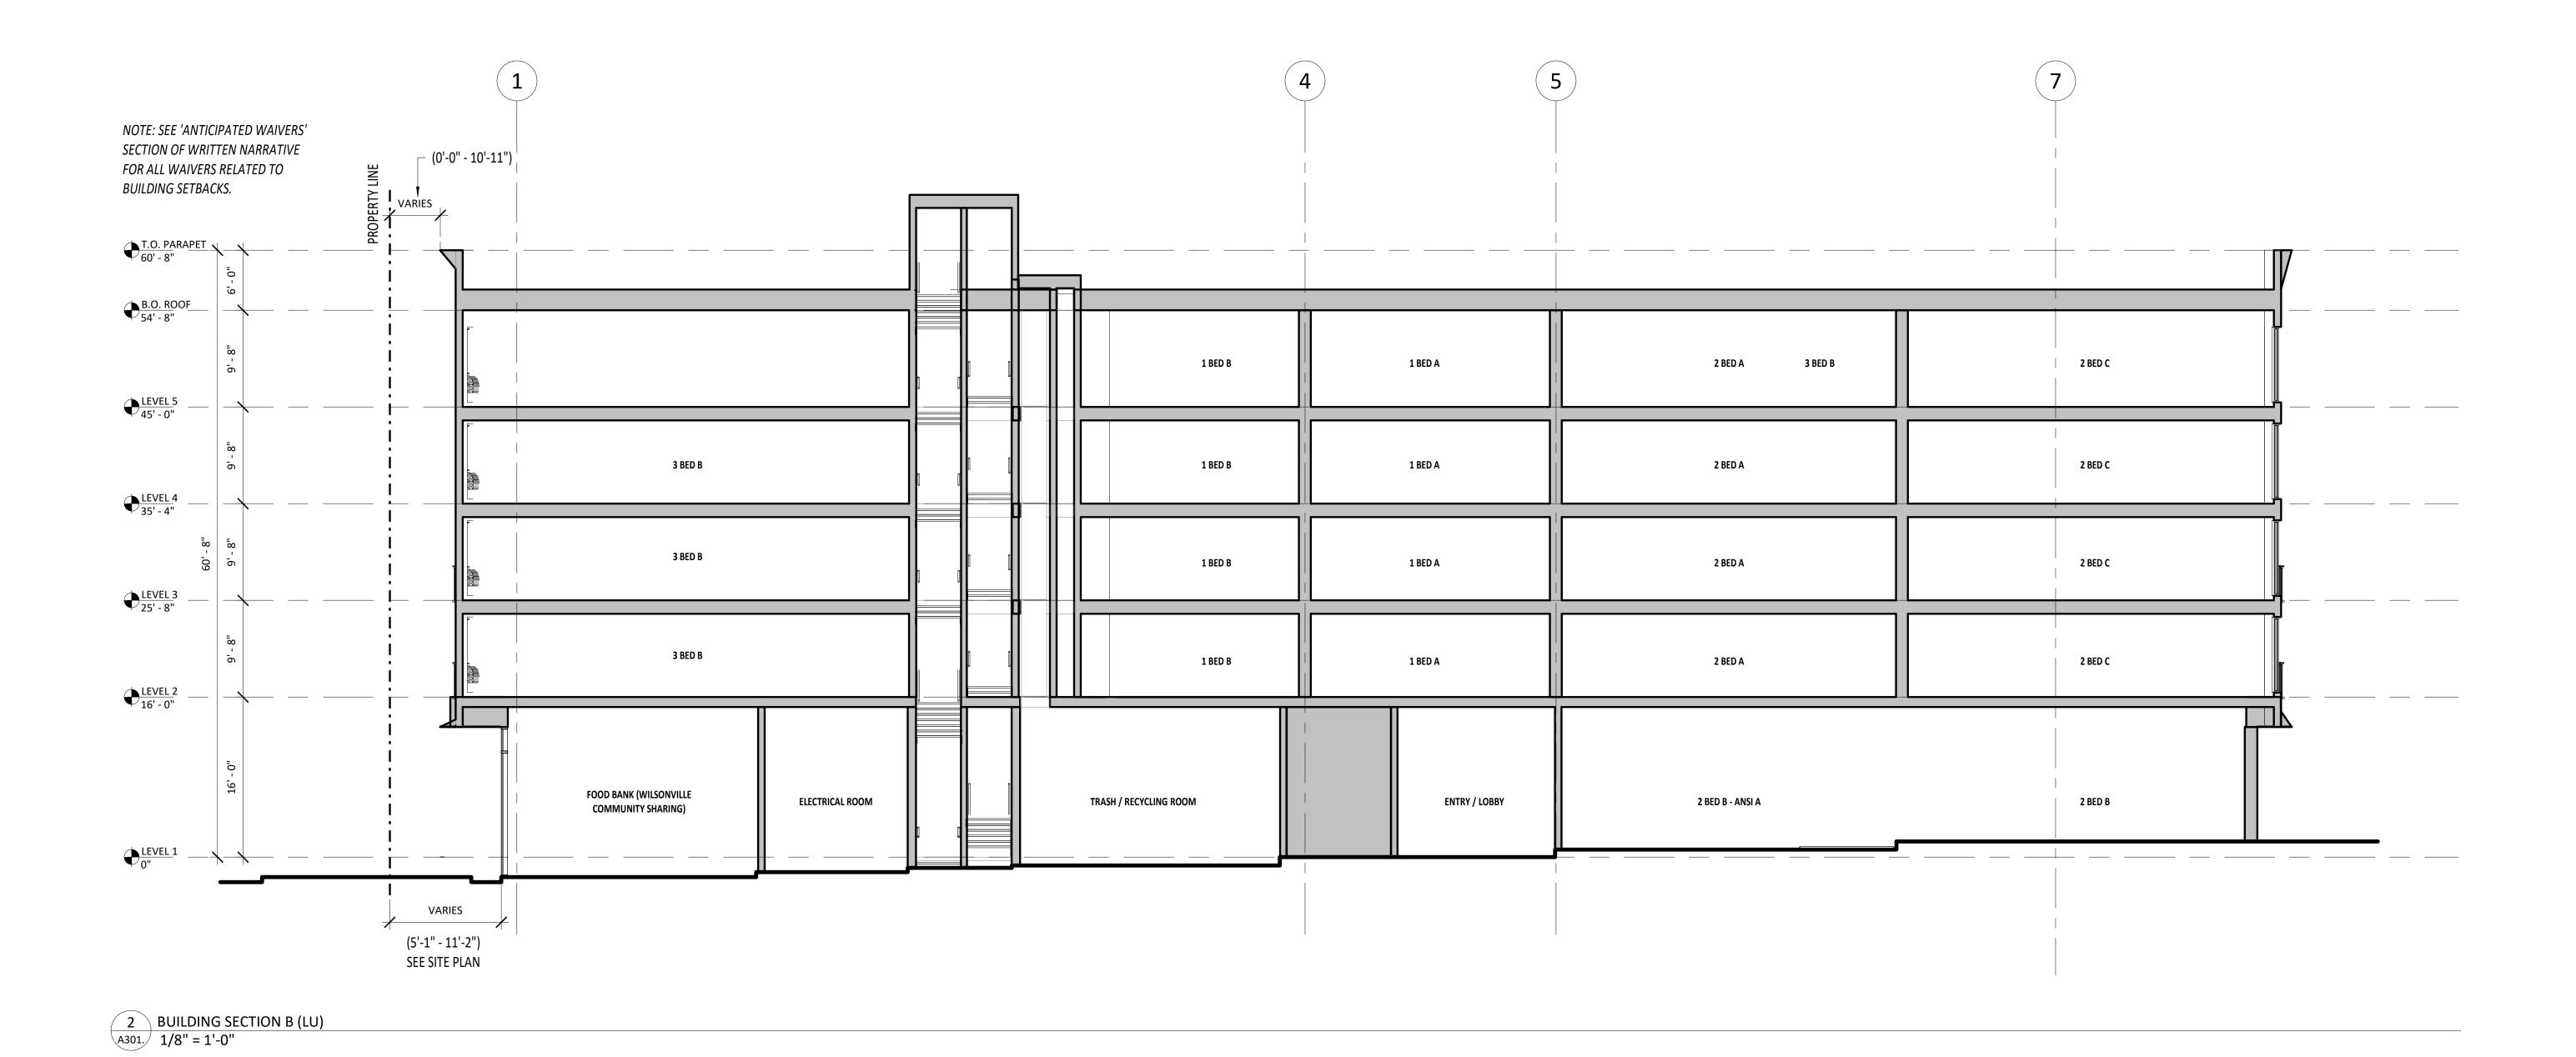

GENERAL NOTES - BUILDING SECTIONS

- 1. FIELD VERIFY ALL INFORMATION PRIOR TO CONSTRUCTION. IF SITE CONDITIONS VARY FROM CONTRACT DOCUMENTS, NOTIFY ARCHITECT IN WRITING IMMEDIATELY.
- 2. ALL STAIRS, HANDRAILS AND GUARDRAILS ARE TO MEET CODE REQUIREMENTS. MAXIMUM STAIR RISE = 7". MINIMUM STAIR RUN = 11".
- 3. ALL STRUCTURAL MEMBERS SHOWN HERE ARE DIAGRAMMATIC SEE STRUCTURAL 4. REFER TO G-000 SERIES DRAWINGS FOR CODE SUMMARY AND EXTENT OF FIRE-RATED CONSTRUCTION.
- 5. REFER TO CIVIL DRAWINGS FOR GRADING AND HORIZONTAL CONTROL DRAWINGS. 6. REFER TO LANDSCAPE DRAWINGS FOR ALL SITE MATERIALS, LAYOUT, AND ACCESS
- COMPLIANCE SITE PATH OF TRAVEL DRAWINGS.

KEY NOTES

T: 971.888.5107 - E-MAIL: INFO@YB-A.COM

REFERENCE ONLY

SHEET REVISION REVISION NO. EVENT

REVISION DATE

TRUE PLAN NORTH **WILSONVILLE TOD**

PALINDROME COMMUNITIES

LAND USE REVIEW PROJECT NUMBER **220120**

DATE 08/18/23

30 X 42

BUILDING SECTIONS (LU)

A301.

GENERAL NOTES - BUILDING SECTIONS 1. FIELD VERIFY ALL INFORMATION PRIOR TO CONSTRUCTION. IF SITE CONDITIONS VARY FROM CONTRACT DOCUMENTS, NOTIFY ARCHITECT IN WRITING IMMEDIATELY. 2. ALL STAIRS, HANDRAILS AND GUARDRAILS ARE TO MEET CODE REQUIREMENTS. MAXIMUM STAIR RISE = 7". MINIMUM STAIR RUN = 11". 3. ALL STRUCTURAL MEMBERS SHOWN HERE ARE DIAGRAMMATIC - SEE STRUCTURAL

T: 971.888.5107 - E-MAIL: INFO@YB-A.COM


REFERENCE

ONLY

REVISION DATE

4. REFER TO G-000 SERIES DRAWINGS FOR CODE SUMMARY AND EXTENT OF FIRE-RATED CONSTRUCTION.

5. REFER TO CIVIL DRAWINGS FOR GRADING AND HORIZONTAL CONTROL DRAWINGS. 6. REFER TO LANDSCAPE DRAWINGS FOR ALL SITE MATERIALS, LAYOUT, AND ACCESS COMPLIANCE SITE PATH OF TRAVEL DRAWINGS.

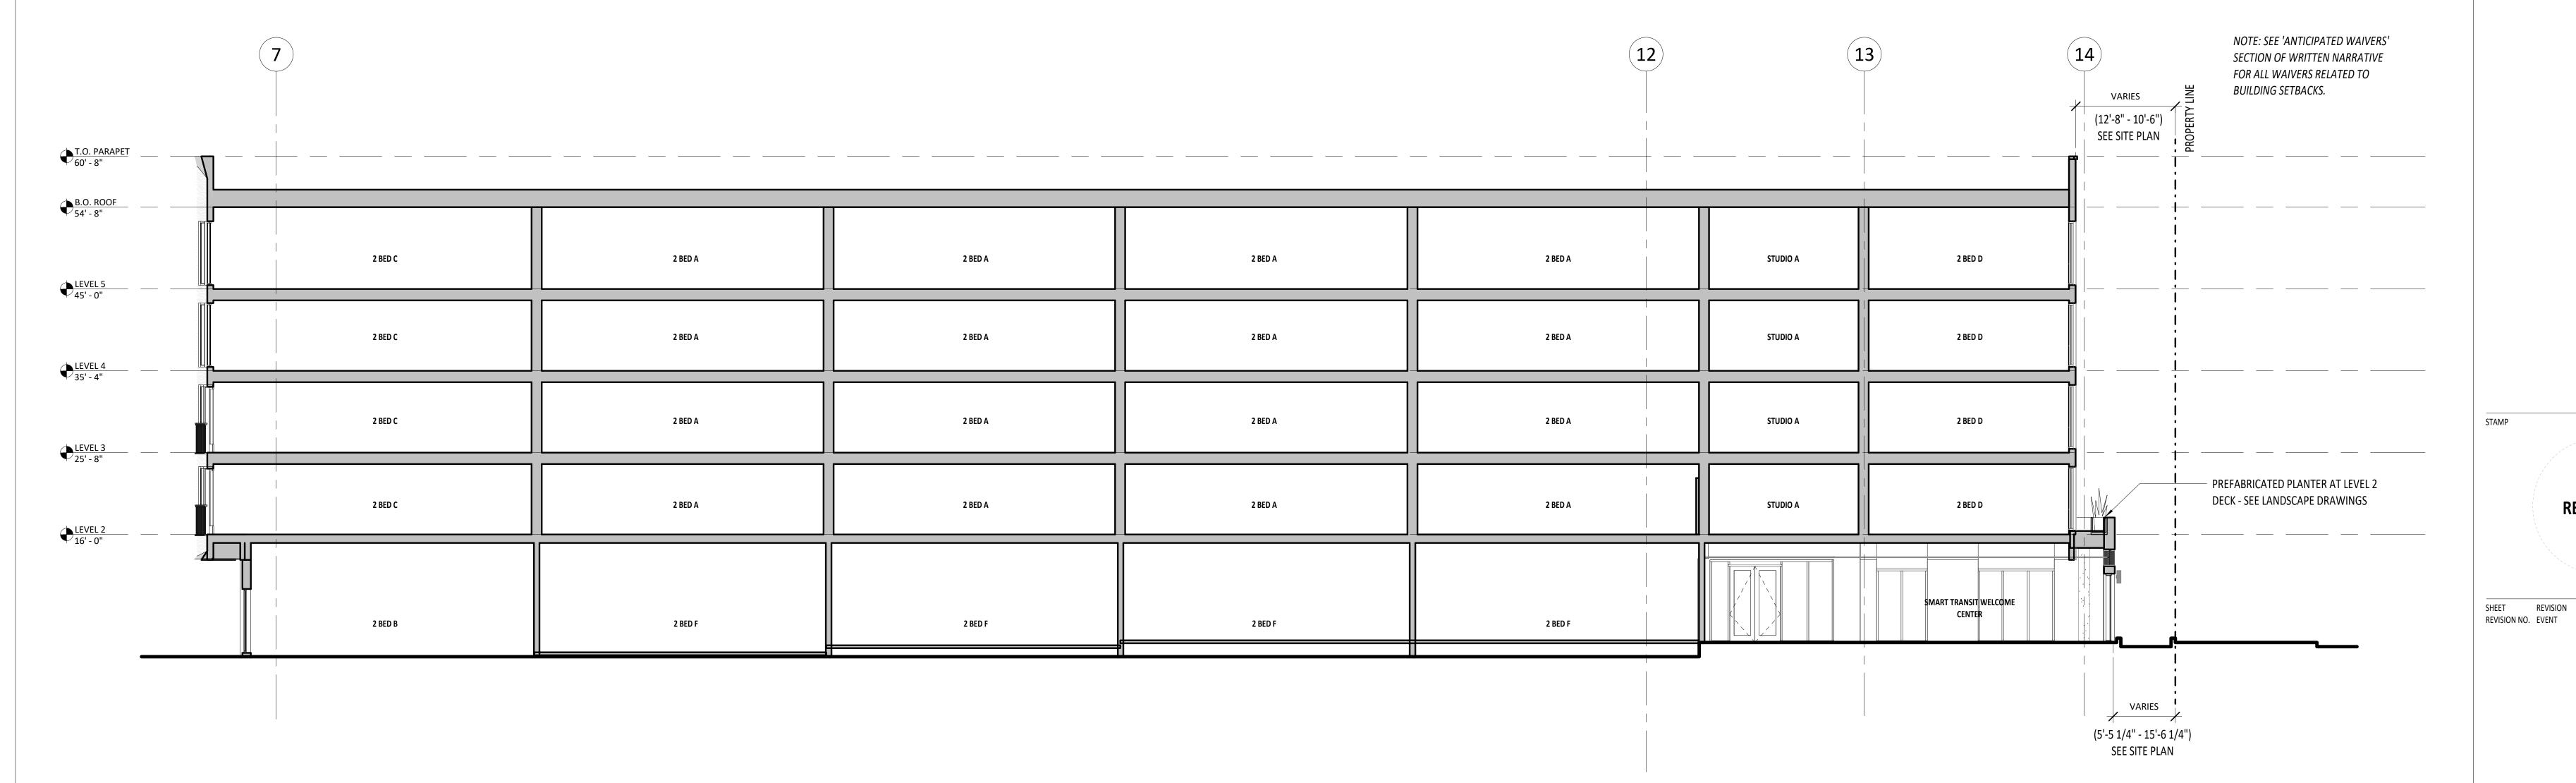

1 BUILDING SECTION C (LU)
A302. 1/8" = 1'-0"

TRUE PLAN NORTH WILSONVILLE TOD

PALINDROME COMMUNITIES

LAND USE REVIEW PROJECT NUMBER **220120**

30 X 42
DRAWING TITLE **BUILDING SECTIONS (LU)**

A302.



VIEW FROM SOUTHEAST CORNER



VIEW FROM NORTHEAST



VIEW FROM NORTHWEST

MATERIAL LEGEND



BRICK VENEER 1: FULL BRICK FINISH: GLAZED, BLUE COLOR LOCATION: GROUND FLOOR MAIN FACADES




BRICK VENEER 2: FULL BRICK FINISH: CLINKER, CHARCOAL COLOR LOCATION: GROUND FLOOR MAIN FACADES



METAL PANEL 1: 18-20 GAUGE METAL PANEL FINISH: BLUE LOCATION: UPPER FLOOR FACADES



METAL PANEL 2: 18-20 GAUGE METAL PANEL FINISH: CHARCOAL GRAY LOCATION: UPPER FLOOR FACADES

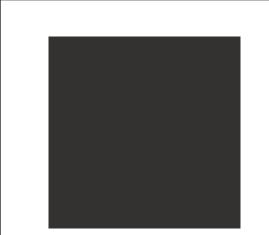

METAL PANEL 3: 18-20 GAUGE METAL PANEL FINISH: BLACK
LOCATION: METAL PANEL BETWEEN WINDOWS,
AND AT UNIT VENTING SLOTS



COMPOSITE WOOD PLANK CLADDING 4"-6" WIDE PLANK LOCATION: UPPER FLOOR PROMINENT FACADES, BUILDING ENTRIES/EXITS, EXTERIOR SOFFITS



BOARD-FORMED CONCRETE, STAINED LOCATION: GROUND FLOOR UNIT PLANTER/ LOW SCREENING WALLS




PERFORATED METAL PANEL LOCATION: UPPER FLOOR FACADES, USED TO CONCEAL UNIT INTAKE VENTS



CUSTOM LOUVER BLACK FINISH LOCATION: EXHAUST VENTS FOR RESIDENTIAL UNITS & GENERAL BUILDING VENTING



EXTERIOR WALL SCONCE - UP/DOWN LIGHT BLACK FINISH

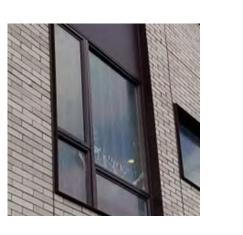

RESIDENTIAL WINDOWS / DOORS VINYL, BLACK




RESIDENTIAL JULIET BALCONY RAILINGS PICKET RAILING, BLACK



ALUMINUM STOREFRONT SYSTEM, BLACK LOCATION: RETAIL/COMMERCIAL TENANT SPACES, GROUND FLOOR COMMON RESIDENTIAL SPACES



STEEL PLATE CANOPIES BLACK TO MATCH STOREFRONTS

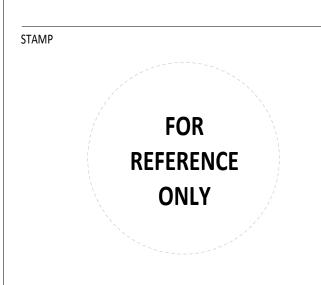

3514 N VANCOUVER AVE SUITE 310 - PORTLAND, OR 97227 T: 971.888.5107 - E-MAIL: INFO@YB-A.COM

SHEET REVISION REVISION NO. EVENT



PALINDROME COMMUNITIES

ISSUANCE	
LAND USE REVIEW	
PROJECT NUMBER 220120	
DATE 08/18/23	
FULL SHEET SIZE	
30 X 42	
DRAWING TITLE	
RENDERINGS	& EXTERIOR

MATERIALS

A900.